CONDITA DIES ... 98810

LAFAYETTE PARK


SALEM, MASSACHUSETTS


KIMBERLEY DRISCOLL, MAYOR




DRAWING LIST

EC 1.00	SITE PLAN OF LAND
L 1.00	SITE DEMOLITION AND PREP PLAN
L 2.00	MATERIALS PLAN
L 2.10	LAYOUT PLAN
L 3.00	GRADING PLAN
L 4.00	PLANTING PLAN
L 5.00	PAVING DETAILS
L 5.10	FURNISHING DETAILS
L 5.11	LIGHTING DETAILS
L 5.20	PLANTING DETAILS
E 0.1	ELECTRICAL SPECIFICATIONS SYMBOLS AND DETAILS
E 1.0	ELECTRICAL SITE PLAN

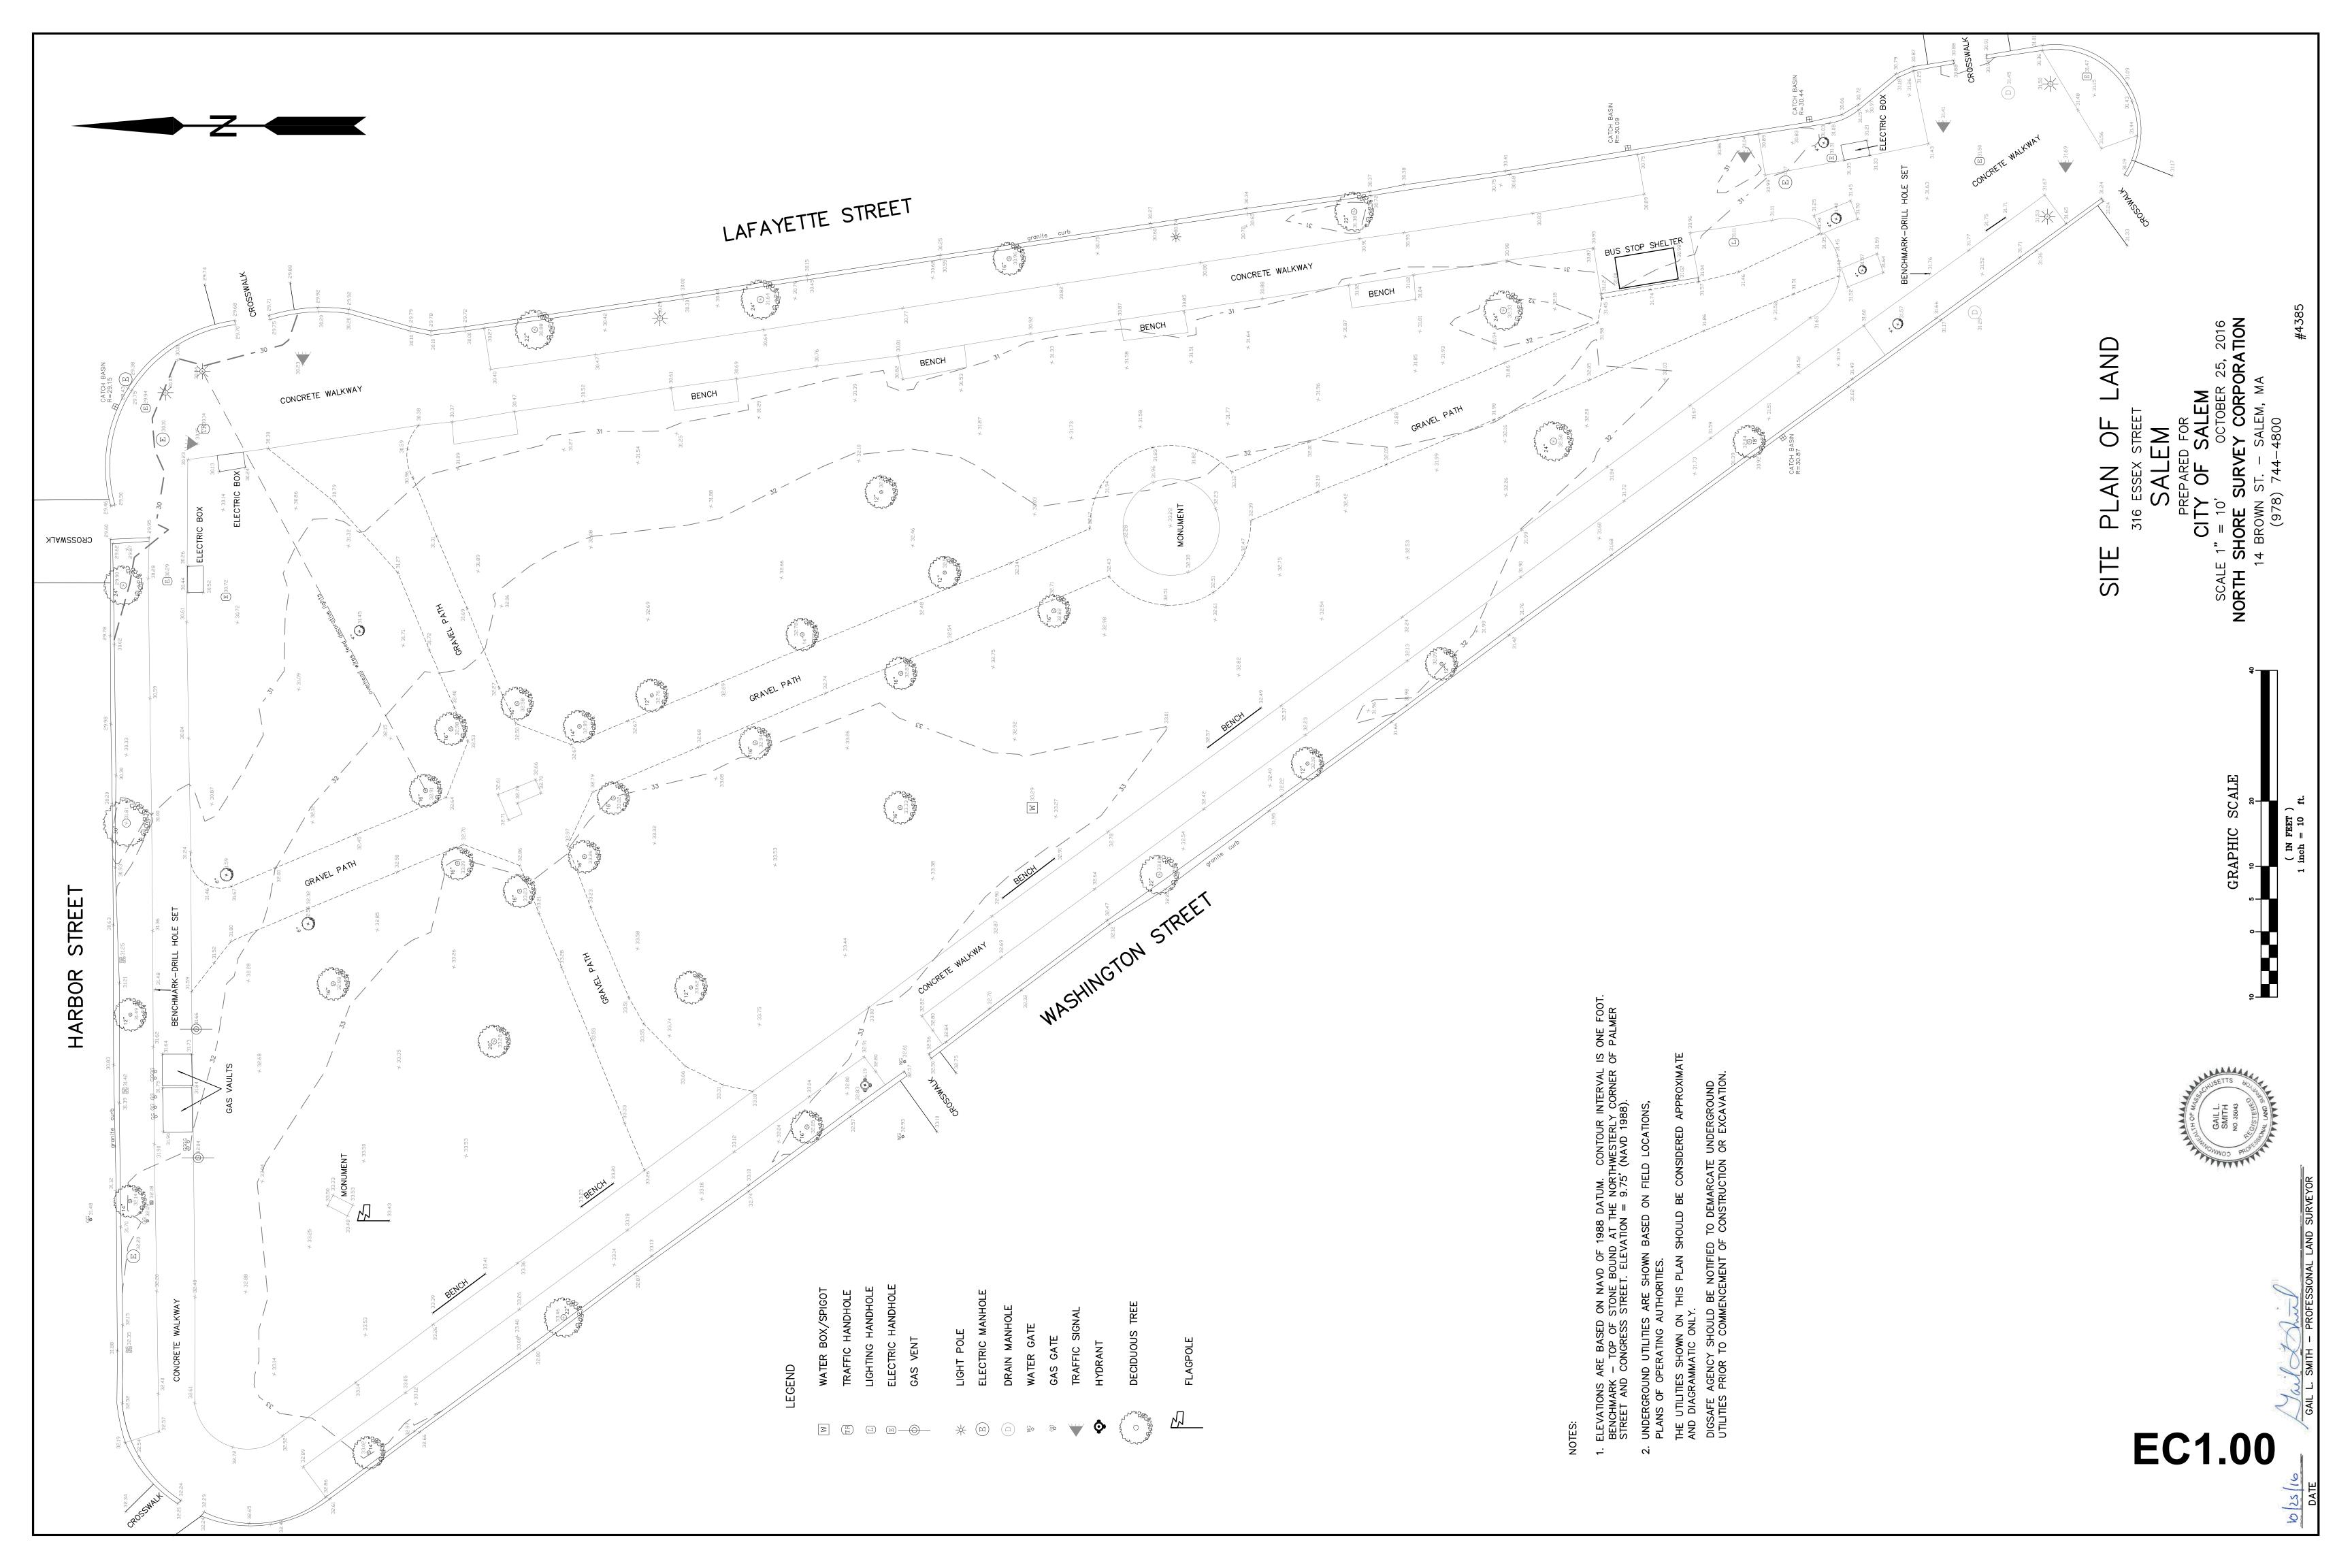

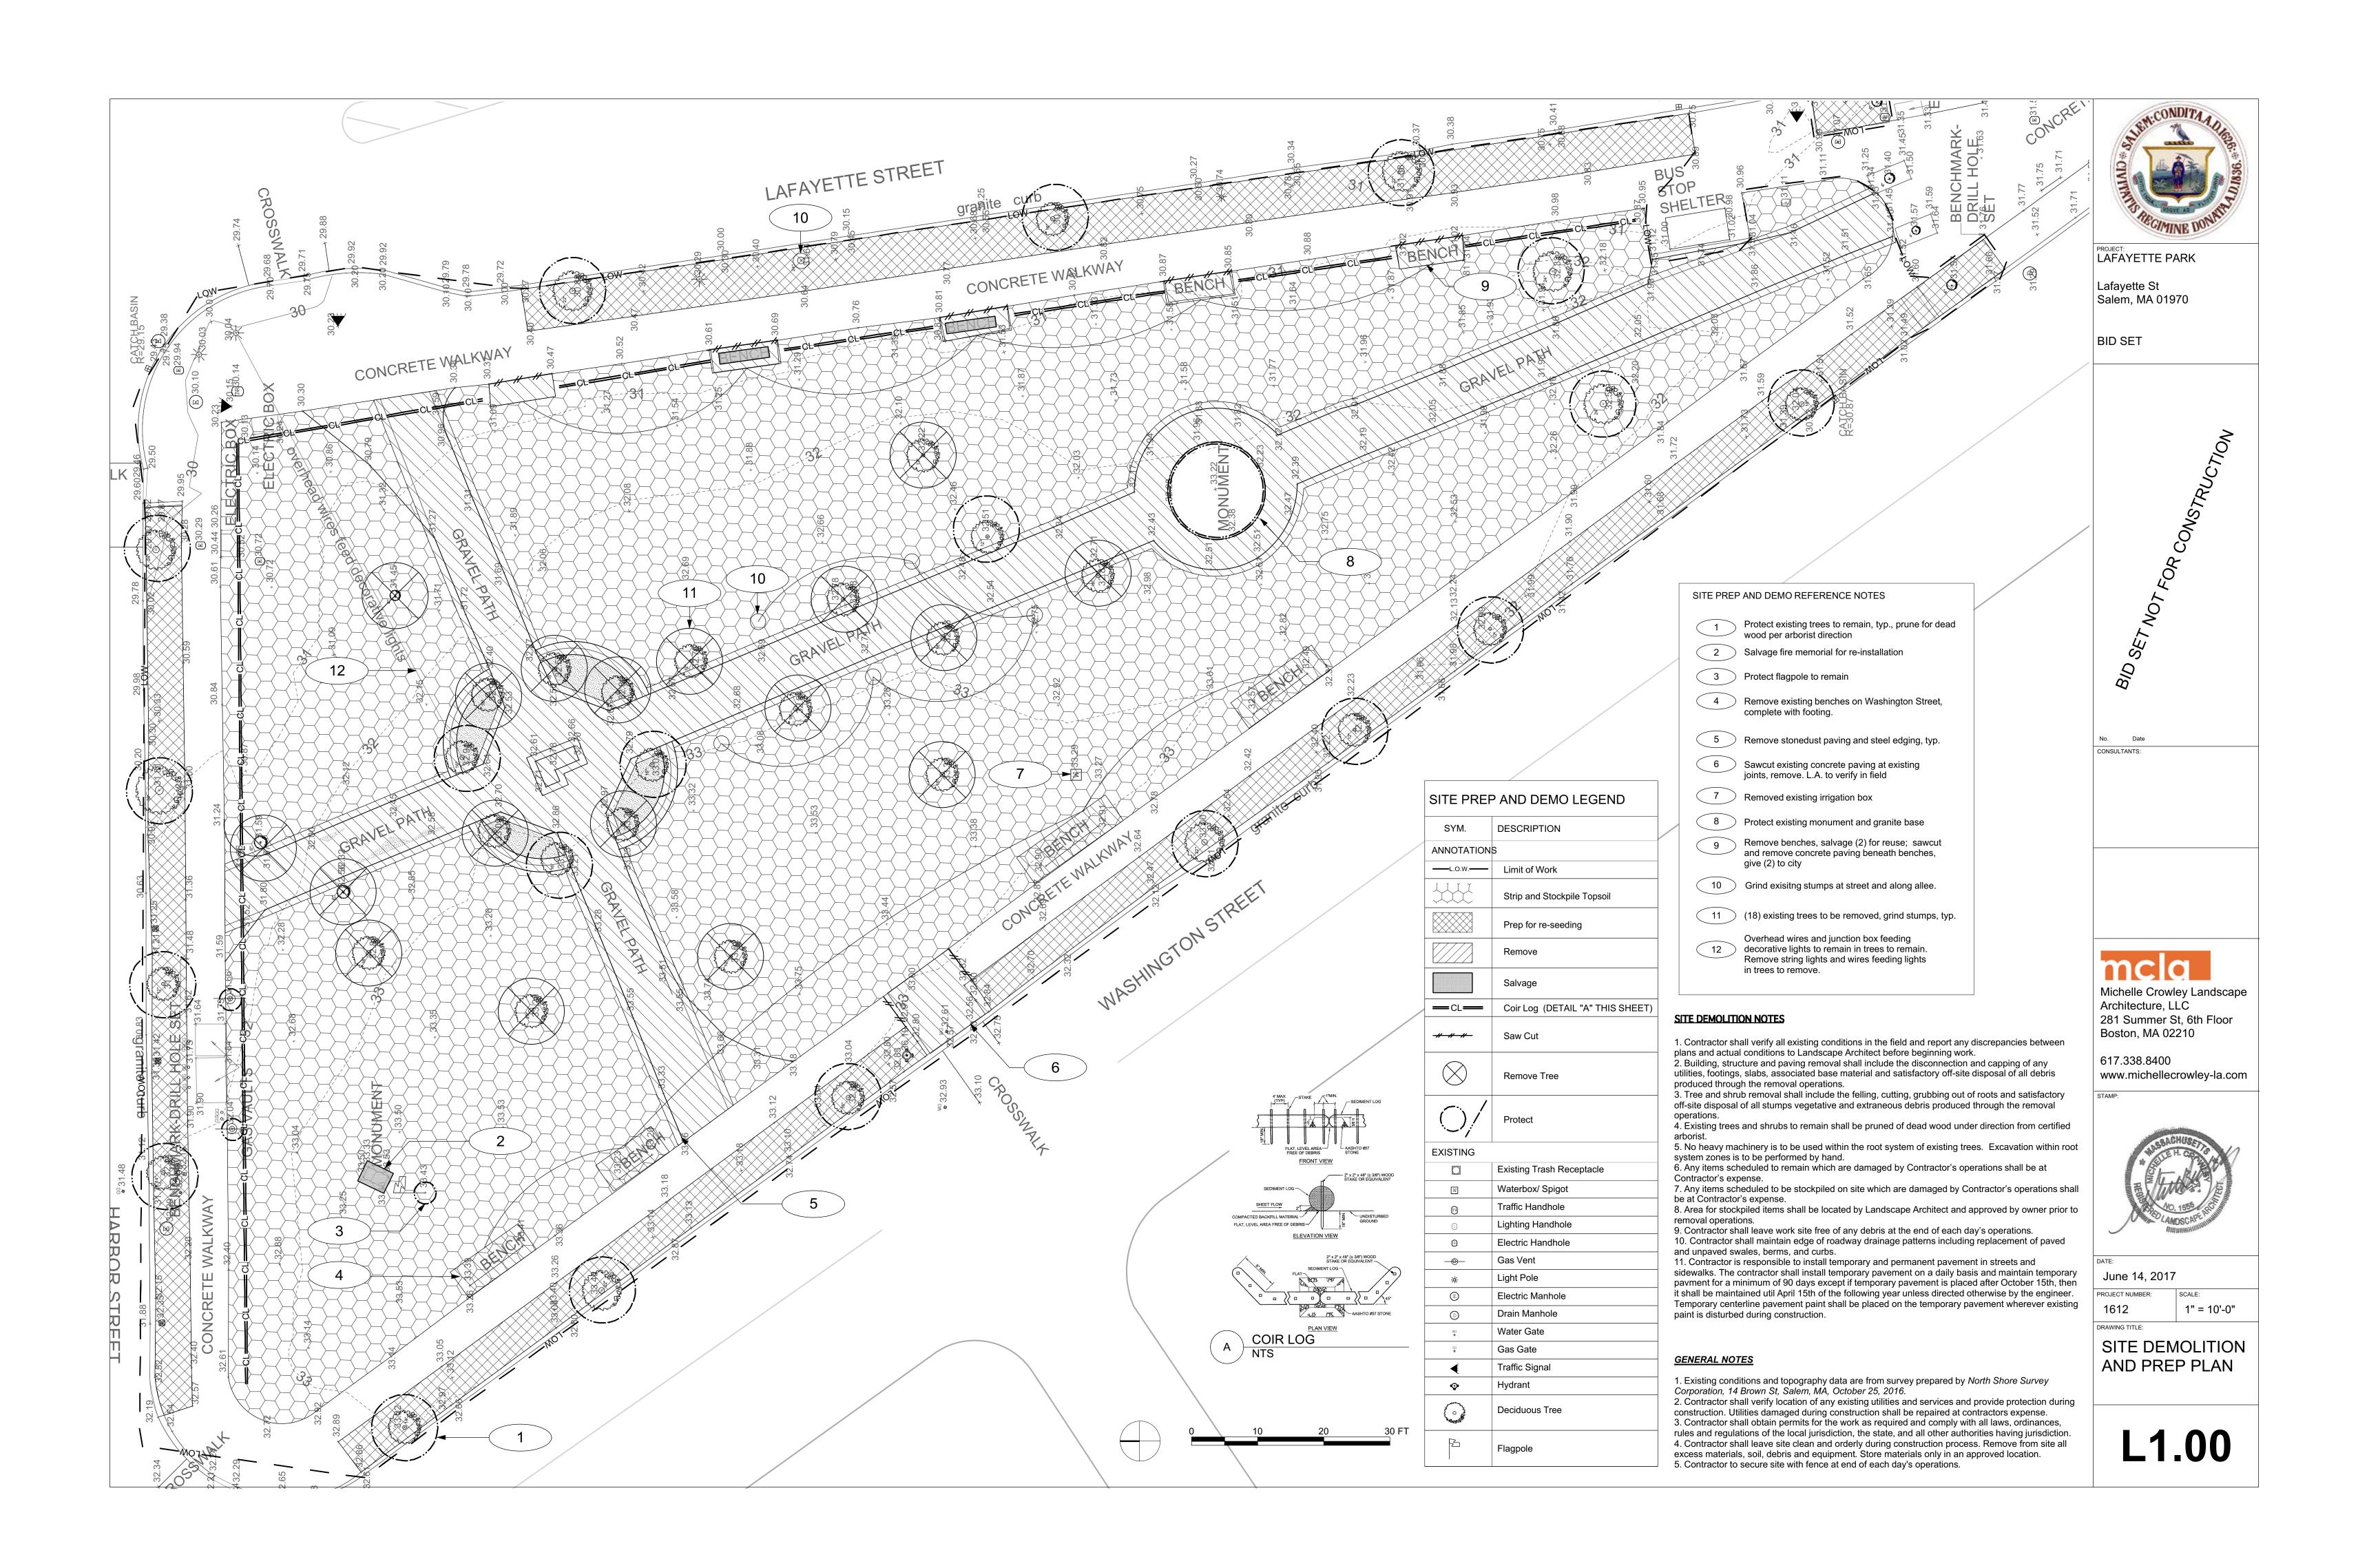

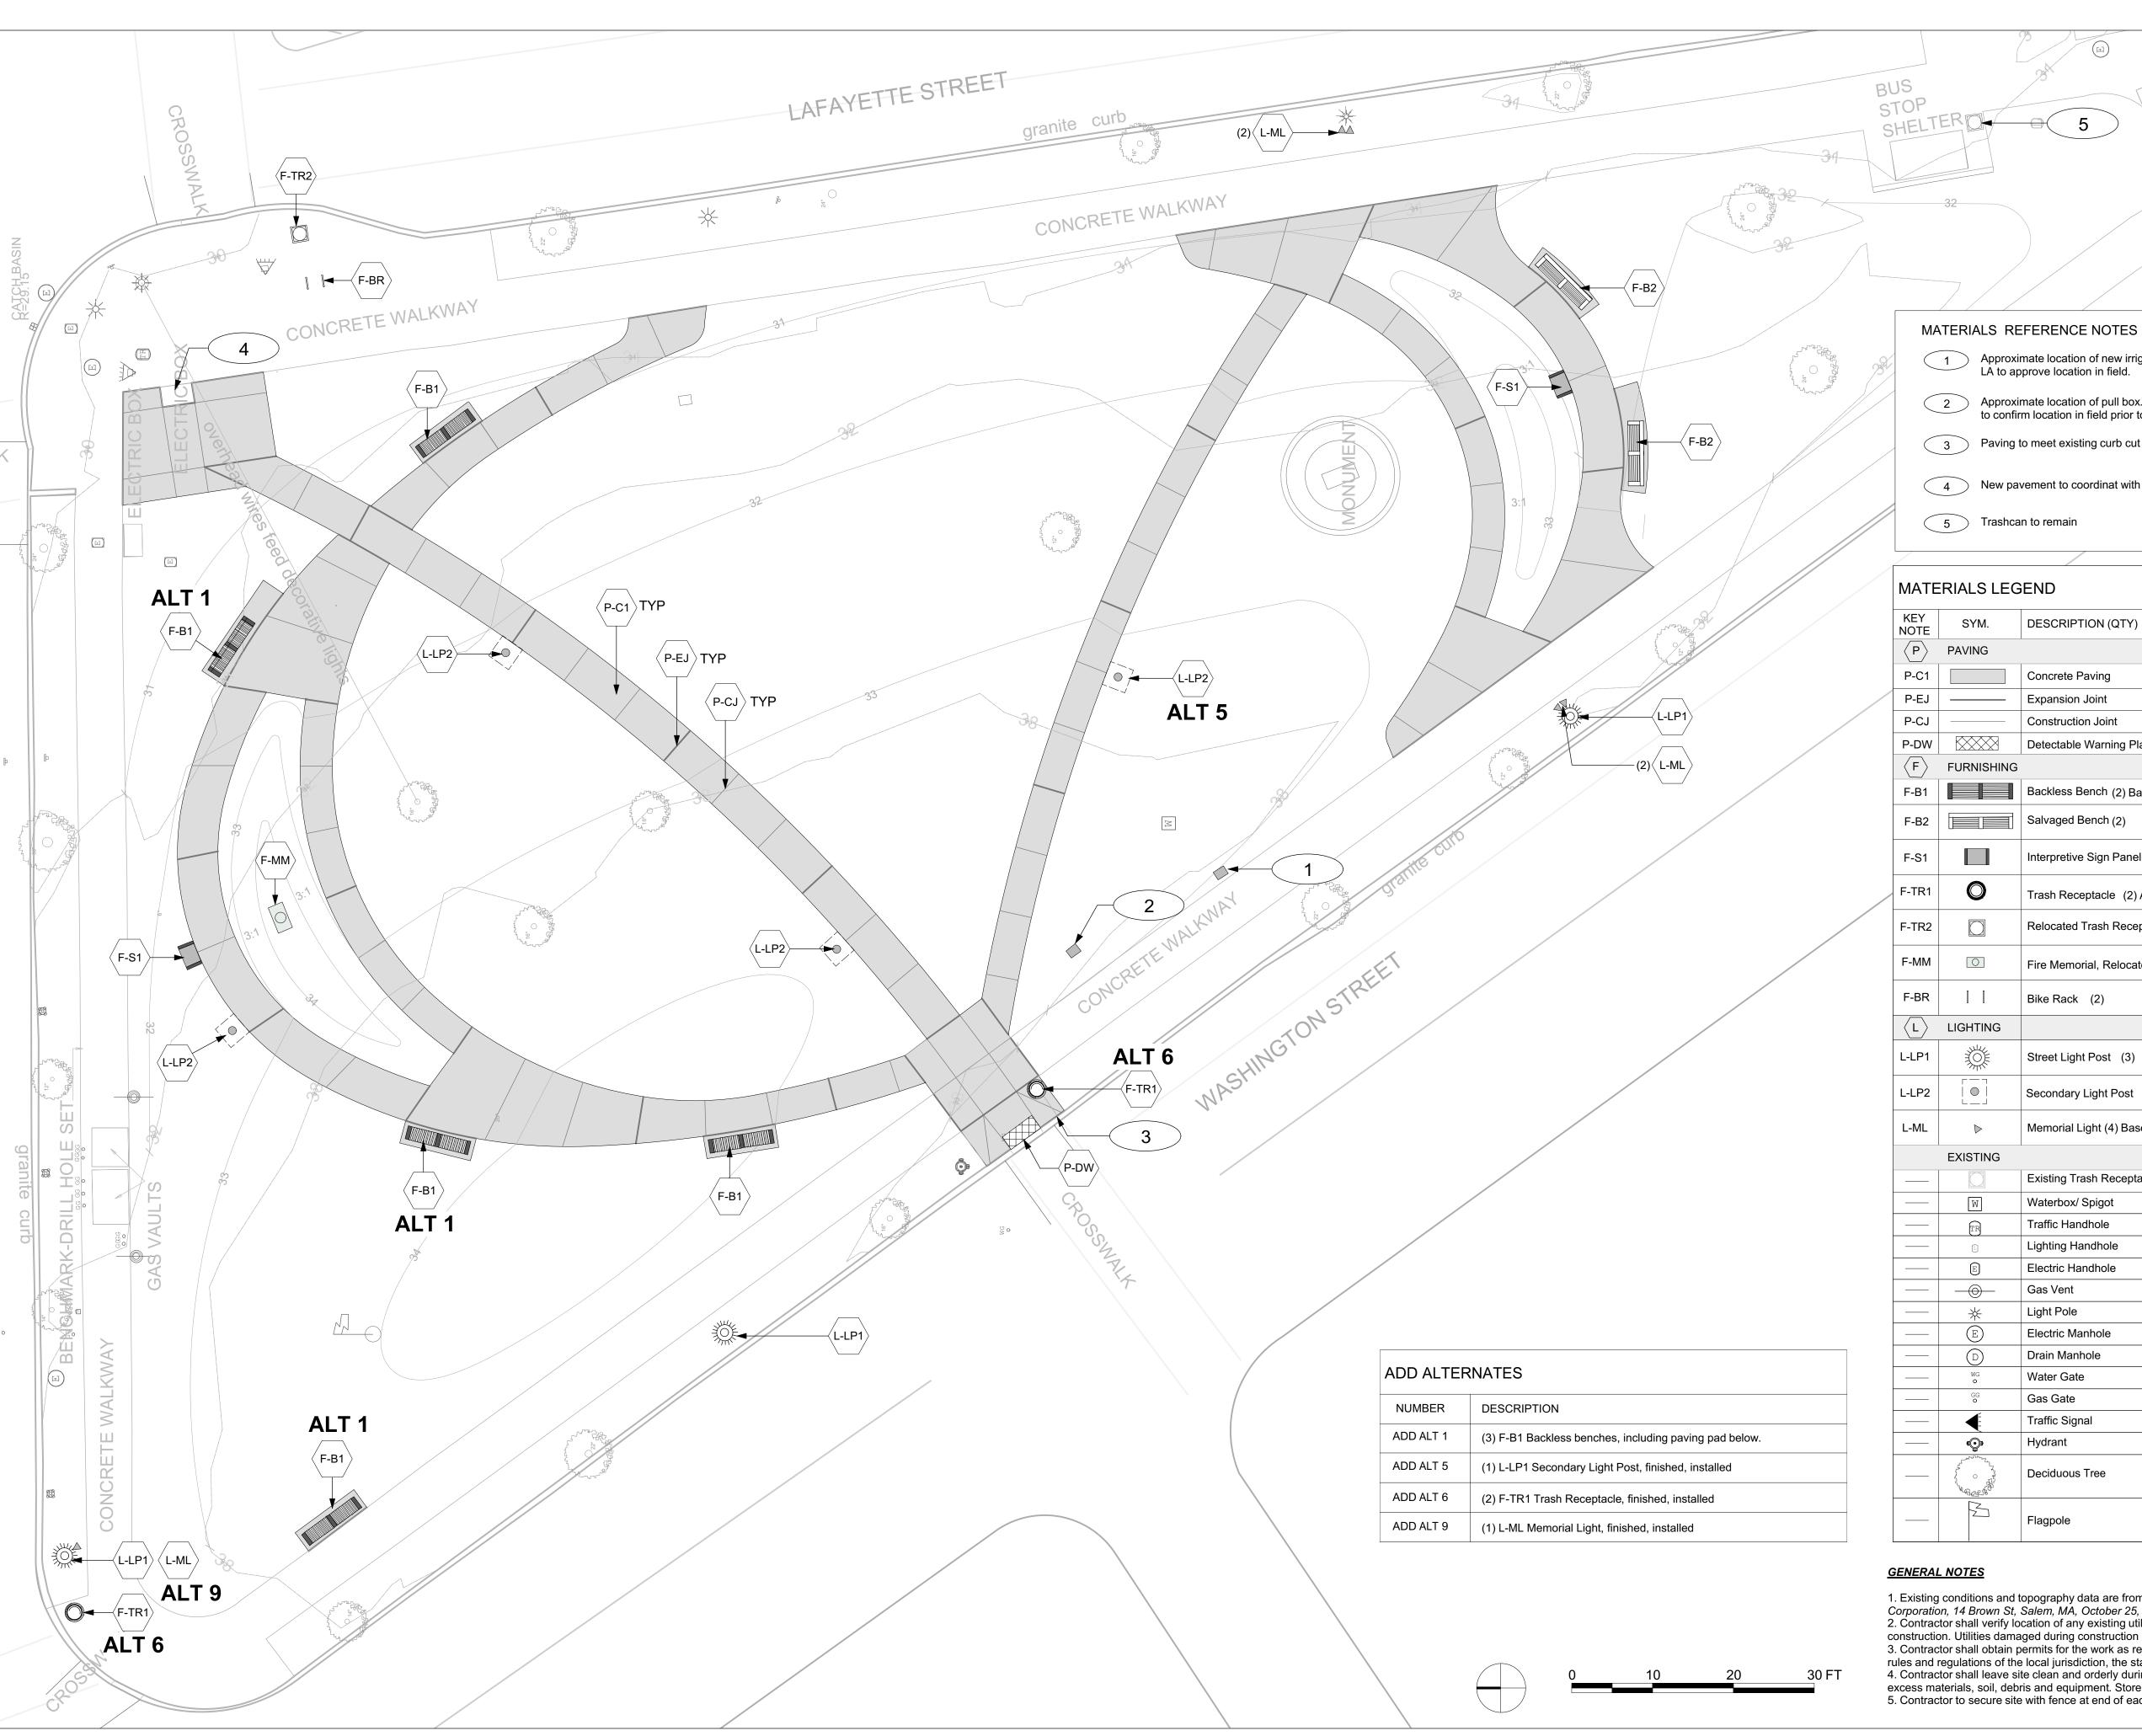



PROJECT:
LAFAYETTE PARK

Lafayette St Salem, MA 01970

BID SET

1 Approximate location of new irrigation cabitent, set in grade. LA to approve location in field.

2 Approximate location of pull box. See electrical drawings. LA to confirm location in field prior to construction.

Paving to meet existing curb cut and meet all ADA standards.

4 New pavement to coordinat with existing utility box.


5 Trashcan to remain

$N \Lambda \Delta^{-}$	TED.	ΙΔΙ	SI	EGEN

MATERIALS LEGEND						
KEY NOTE	SYM.	DESCRIPTION (QTY)	DETAIL/ SHEET	SPEC. SECTION(S)		
P	PAVING					
P-C1		Concrete Paving	1/L5.00			
P-EJ		Expansion Joint	2/L5.00	321313		
P-CJ		Construction Joint	3/L5.00			
P-DW		Detectable Warning Plate	4/L5.00			
F	FURNISHING					
F-B1		Backless Bench (2) Base (3) Alt. 1	1/L5.10	129300		
F-B2		Salvaged Bench (2)	1/L5.10	024113		
F-S1		Interpretive Sign Panel (2)	2/L5.10	101430		
F-TR1	0	Trash Receptacle (2) Alt. 6	3/L5.10	129300		
F-TR2		Relocated Trash Receptacle (1)		024113		
F-MM	0	Fire Memorial, Relocated (1)	4/L5.10	024113		
F-BR		Bike Rack (2)	5/L5.10	129300		
$\langle L \rangle$	LIGHTING					
L-LP1		Street Light Post (3)	1/L5.11			
L-LP2		Secondary Light Post (3) Base (1) Alt. 5	2/L5.11	265200		
L-ML	\triangleright	Memorial Light (4) Base (1) Alt. 8				
	EXISTING					
		Existing Trash Receptacle				
	W	Waterbox/ Spigot				
	TR	Traffic Handhole				
	Ĺ	Lighting Handhole				
	E	Electric Handhole				
		Gas Vent				
	*	Light Pole				
	E	Electric Manhole				
	D	Drain Manhole				
	WG O	Water Gate				
	GG O	Gas Gate				
	4	Traffic Signal				
	•	Hydrant				
	4 4 4 4 4 4 4 4 4 4 4 4 4 4 4 4 4 4 4	Deciduous Tree				
	- 100 m	Flagpole				

 Existing conditions and topography data are from survey prepared by North Shore Survey Corporation, 14 Brown St, Salem, MA, October 25, 2016.
 Contractor shall verify location of any existing utilities and services and provide protection during construction. Utilities damaged during construction shall be repaired at contractors expense. 3. Contractor shall obtain permits for the work as required and comply with all laws, ordinances, rules and regulations of the local jurisdiction, the state, and all other authorities having jurisdiction. 4. Contractor shall leave site clean and orderly during construction process. Remove from site all excess materials, soil, debris and equipment. Store materials only in an approved location.

5. Contractor to secure site with fence at end of each day's operations.

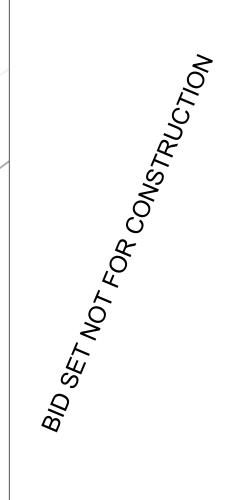

CONSULTANTS:

Michelle Crowley Landscape Architecture, LLC 281 Summer St, 6th Floor Boston, MA 02210

617.338.8400 www.michellecrowley-la.com





June 14, 2017 1612


DRAWING TITLE:


1" =10'


MATERIALS PLAN

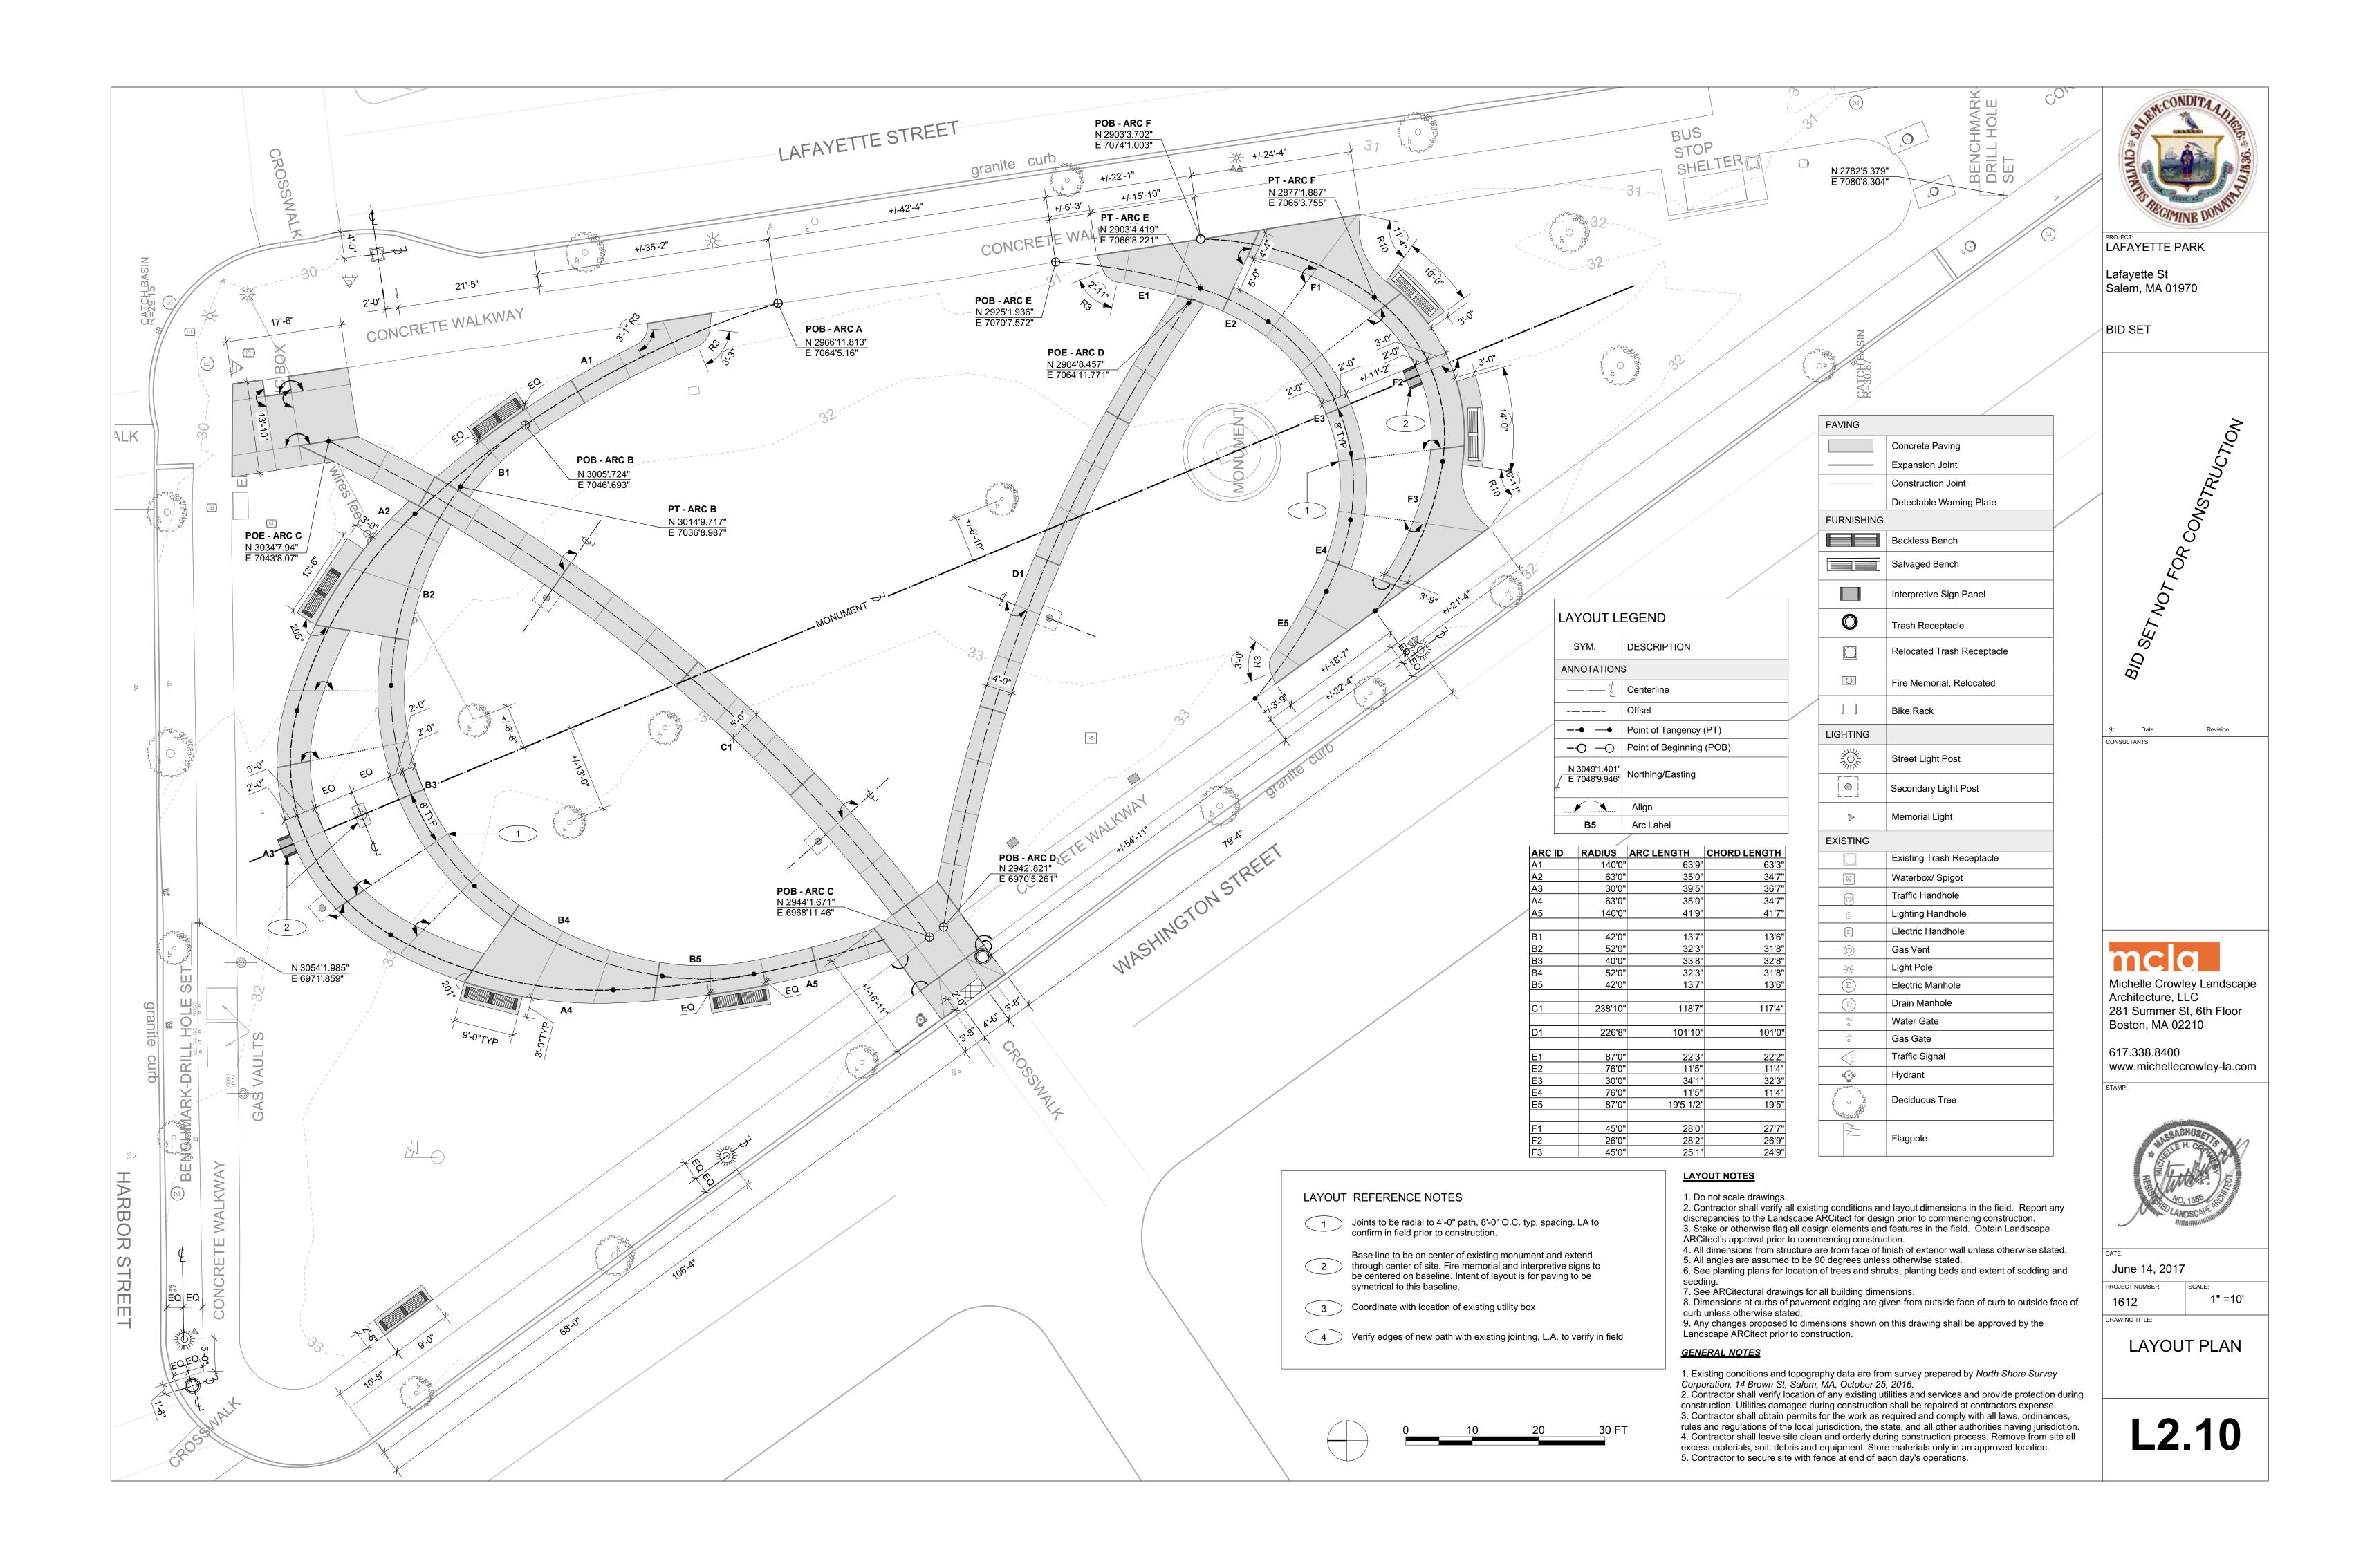


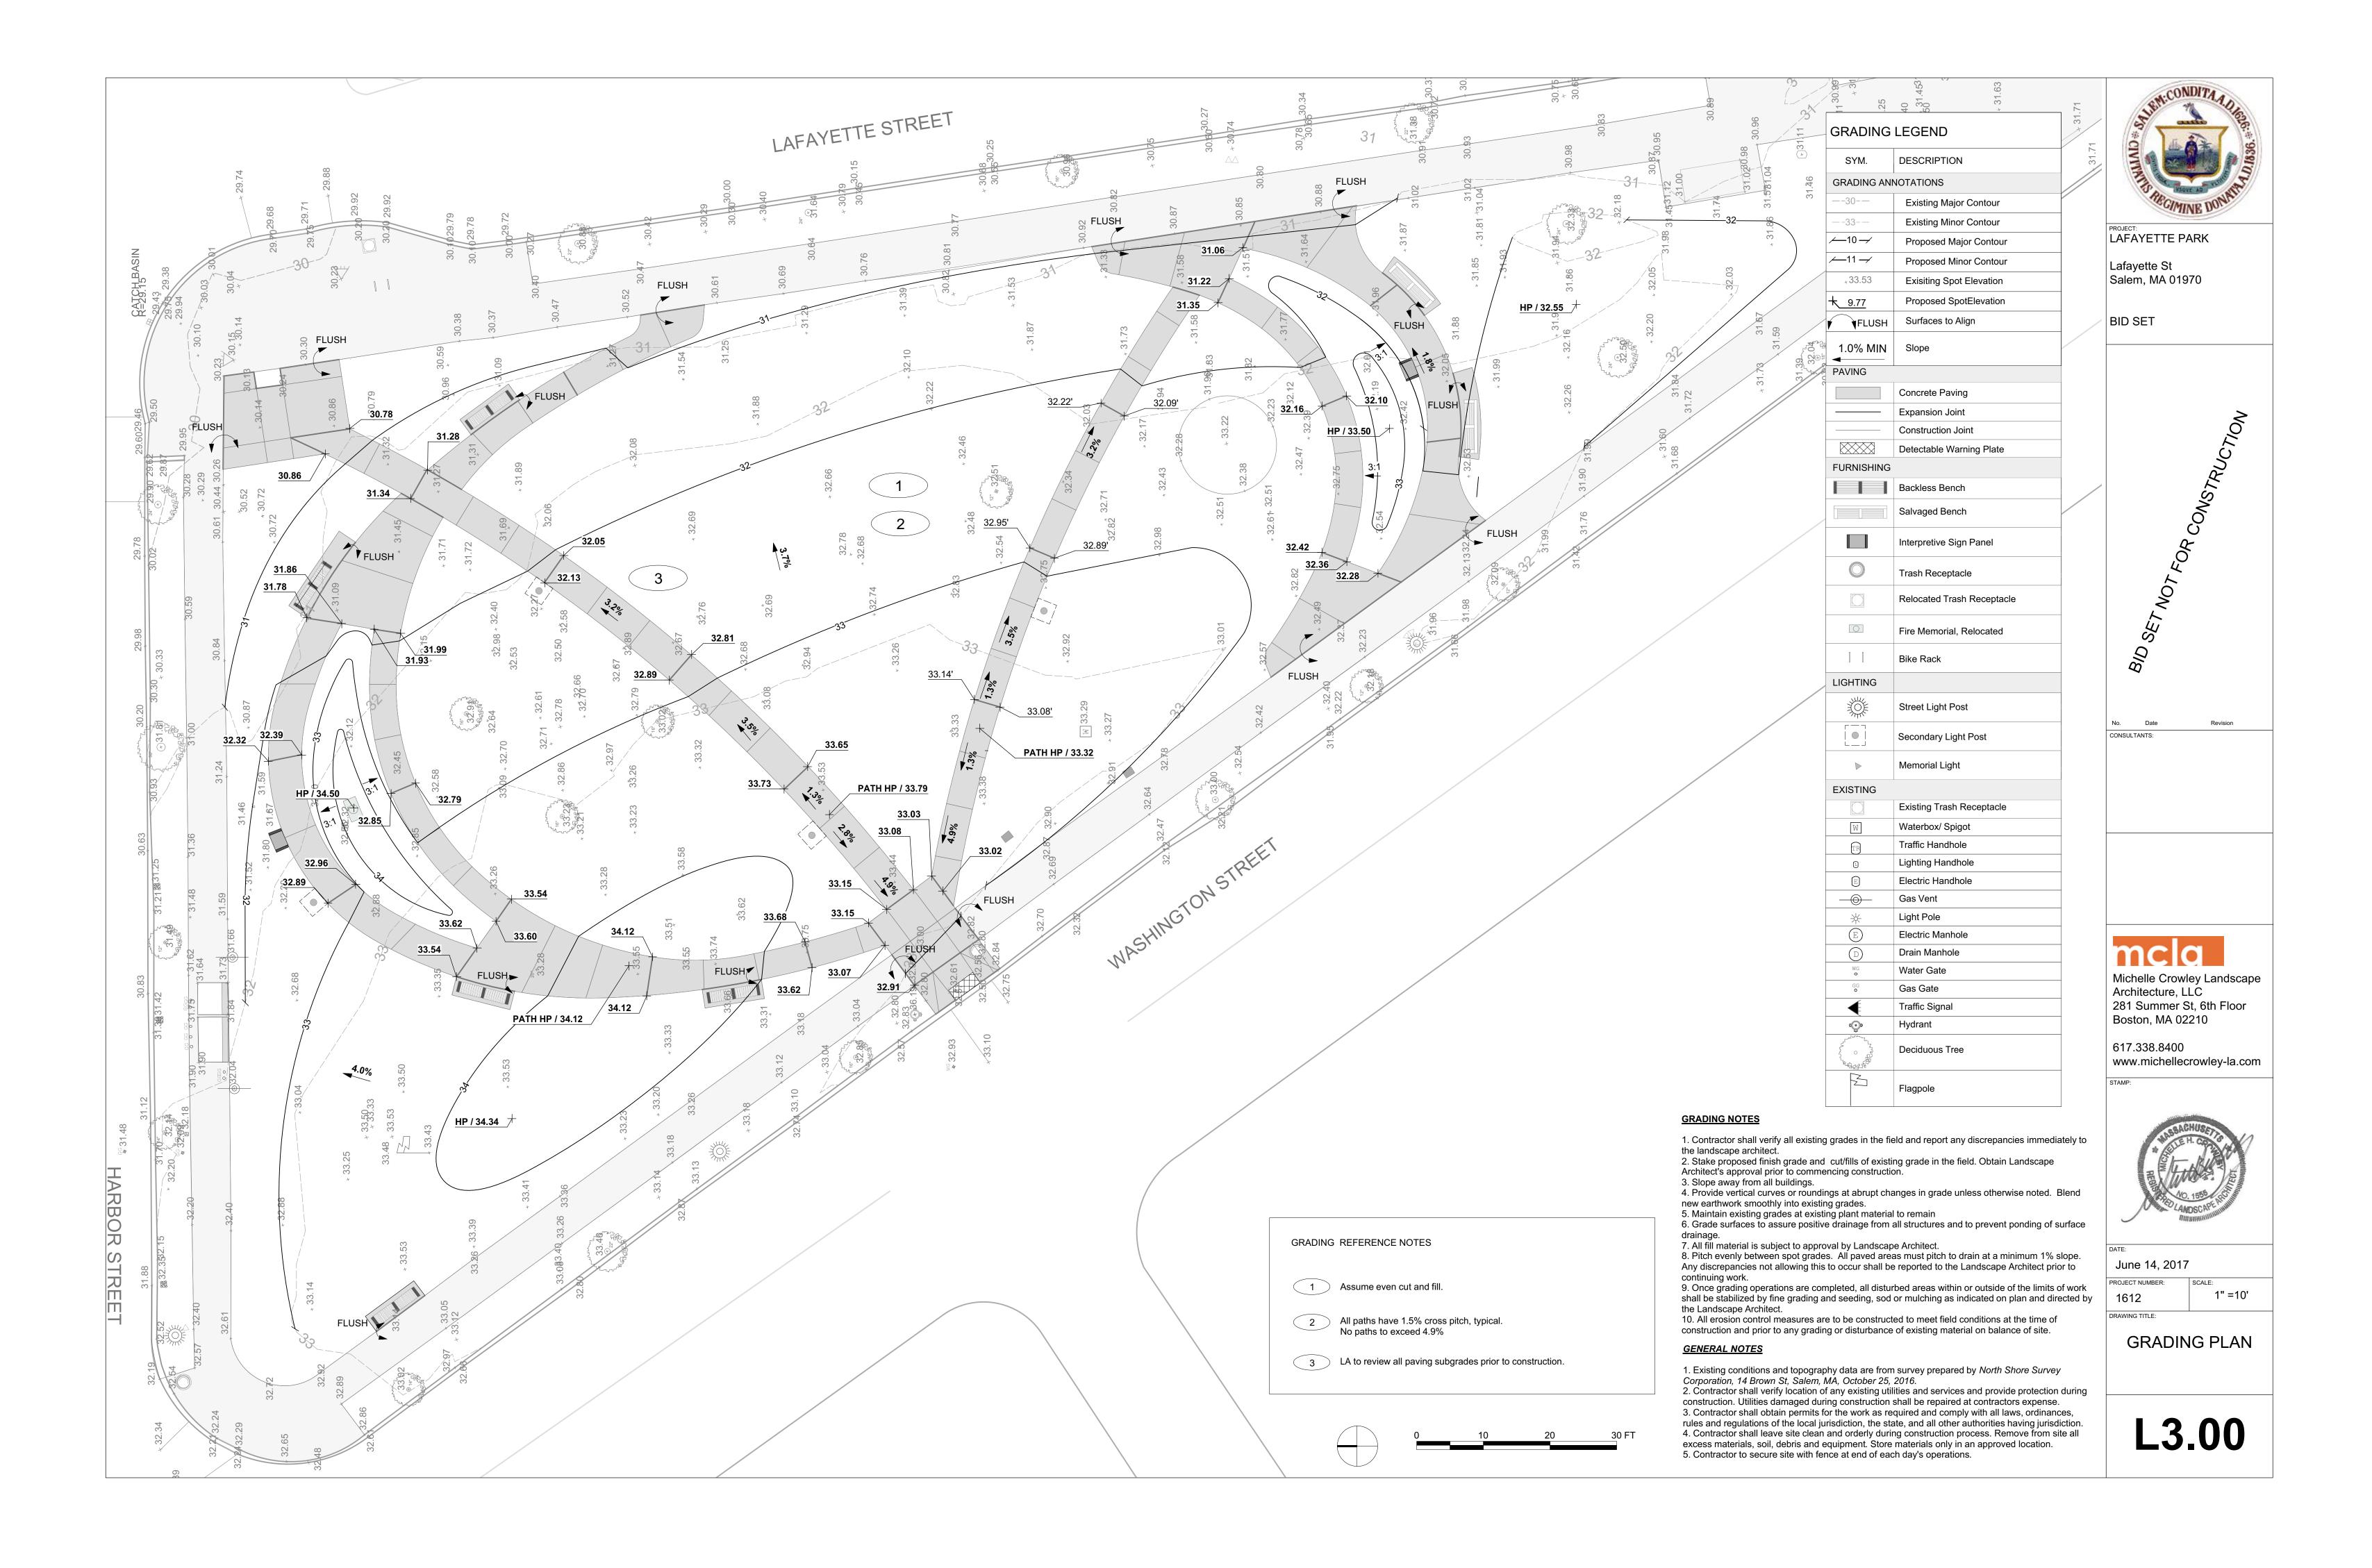

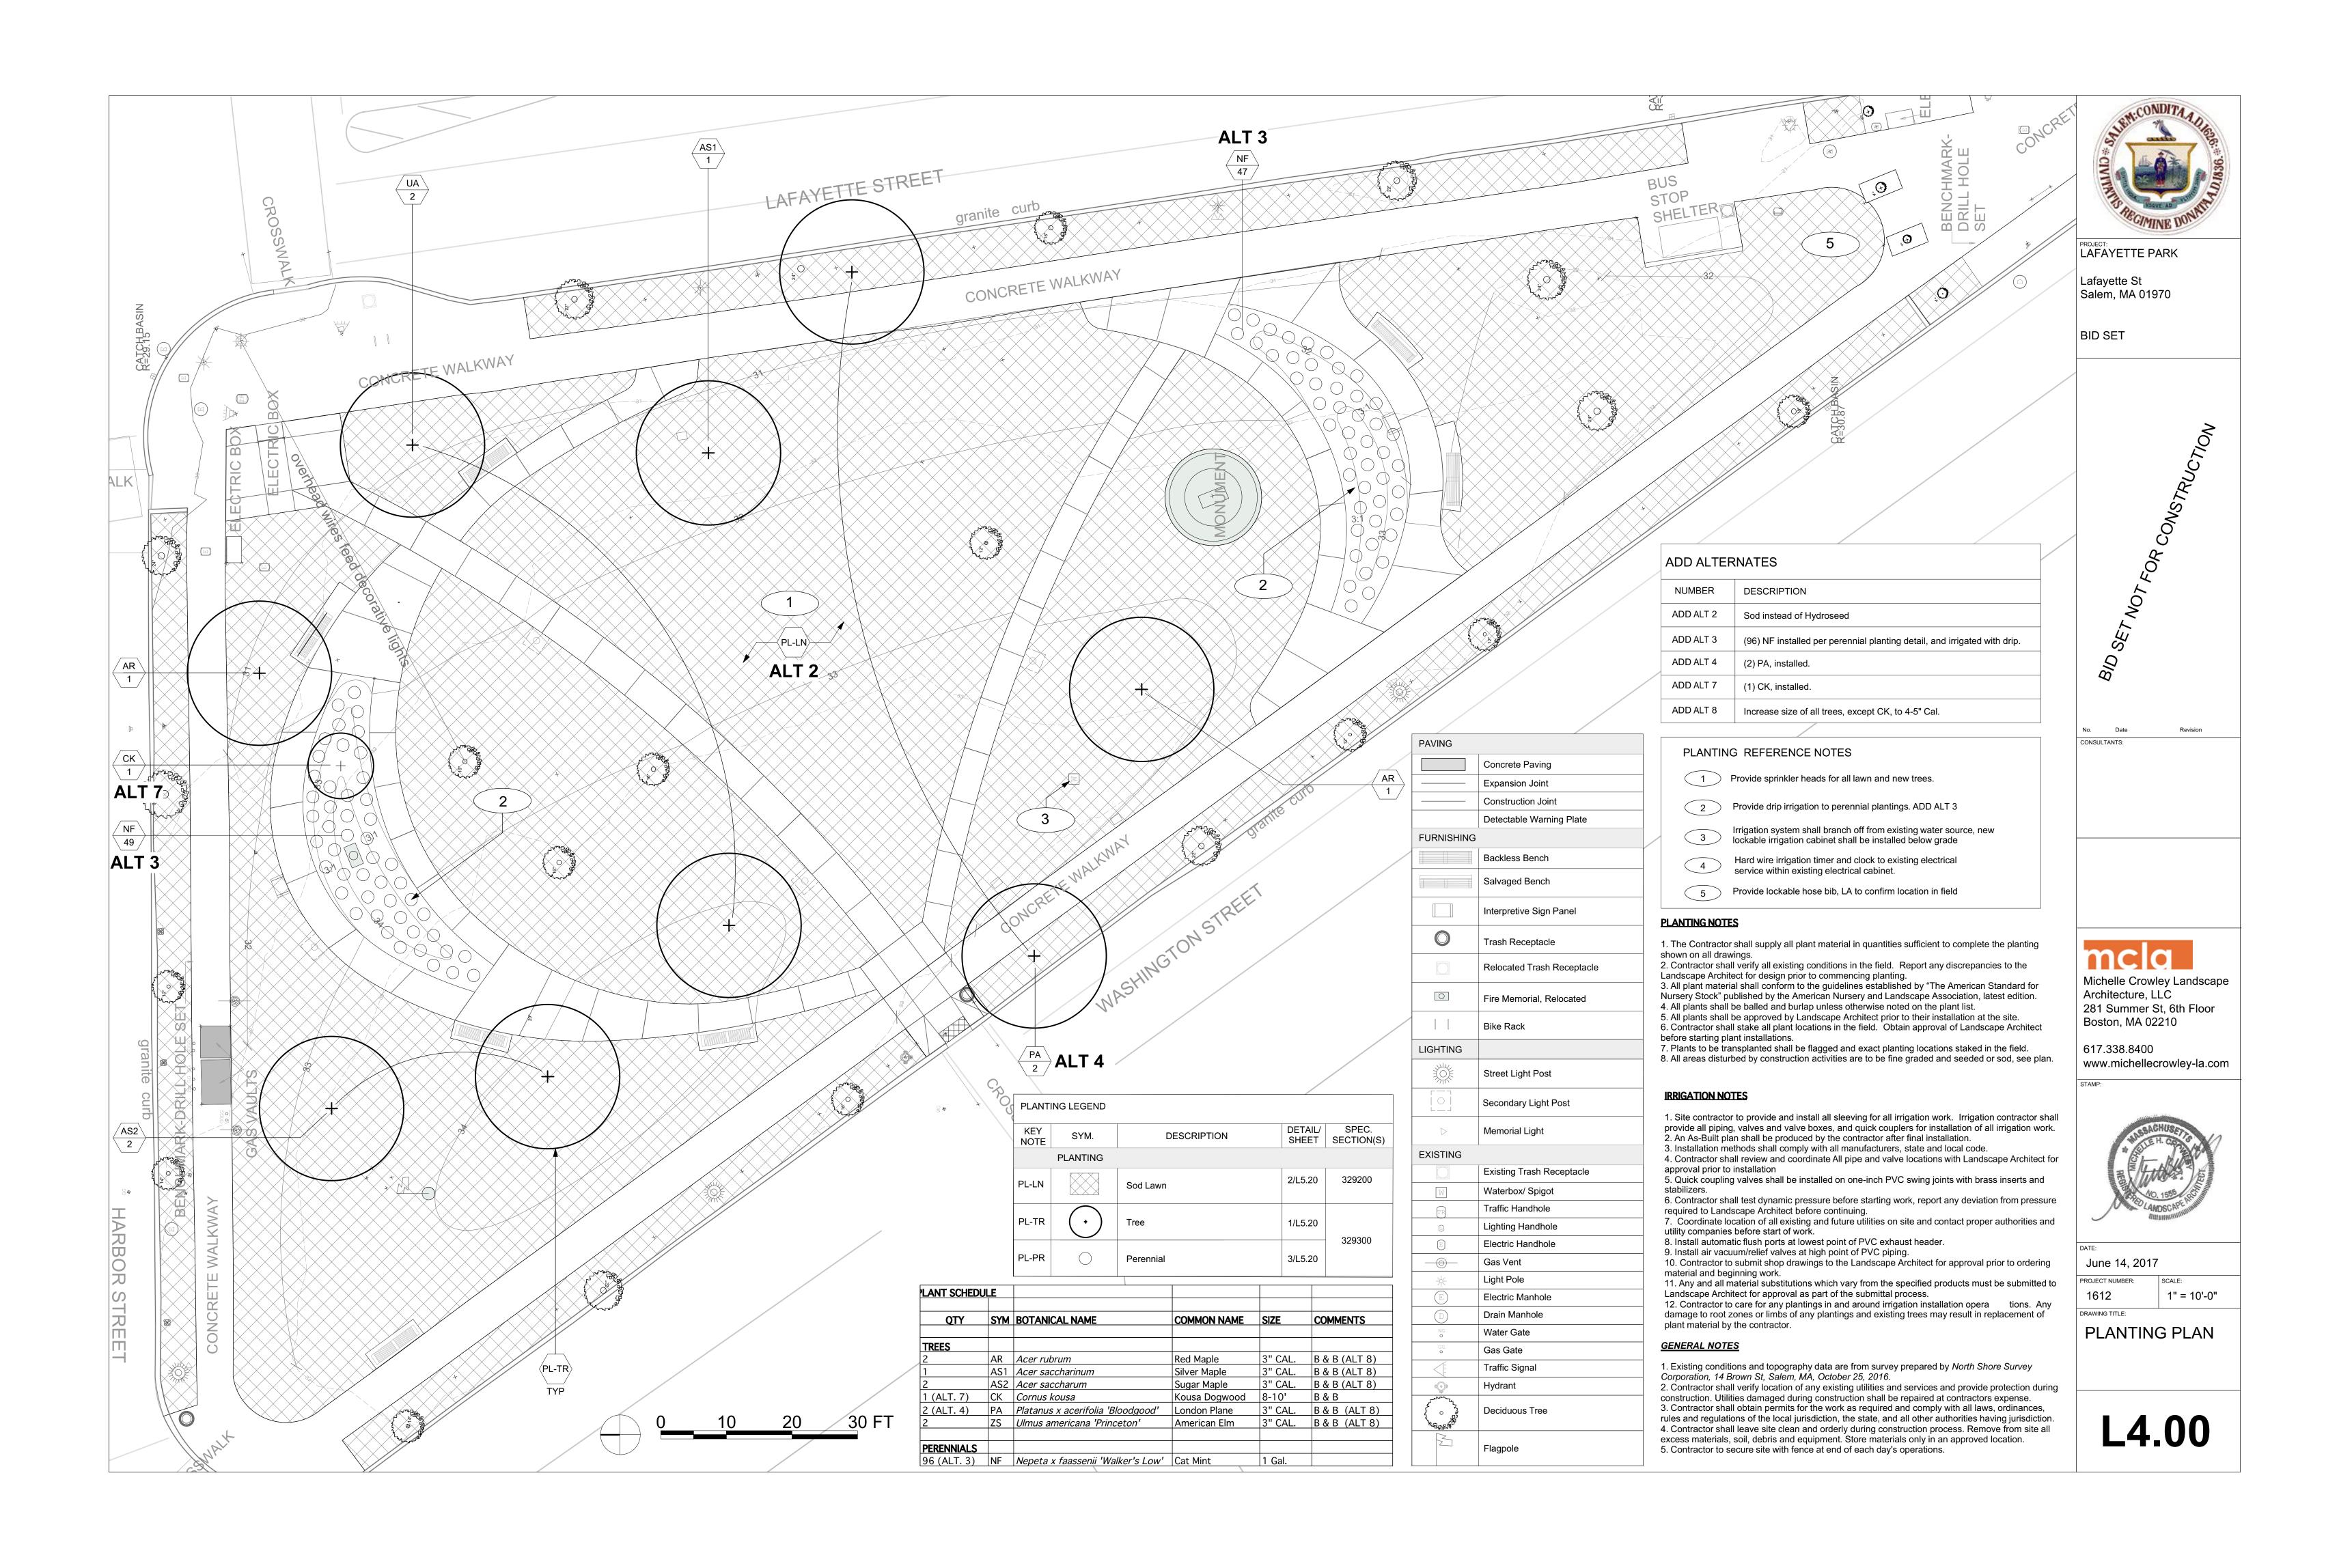

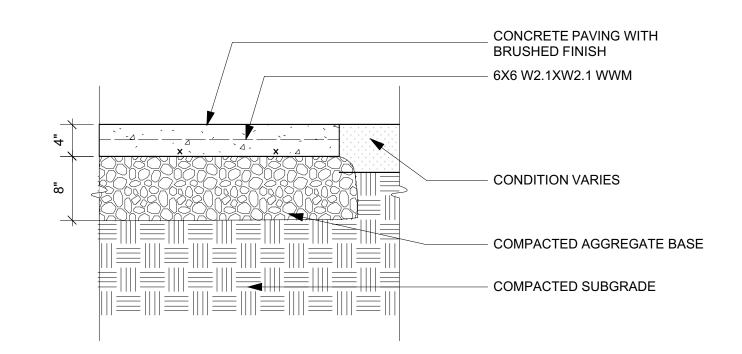


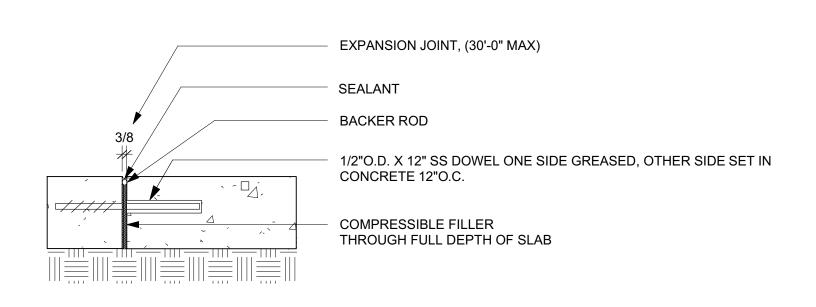

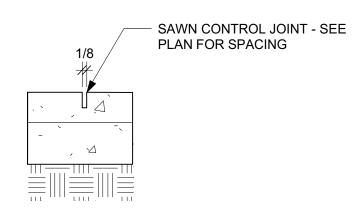


2 (P-EJ) EXPANSION JOINT Scale: 1 1/2" = 1'-0"


3 (P-CJ) CONSTRUCTION JOINT Scale: 1 1/2" = 1'-0"

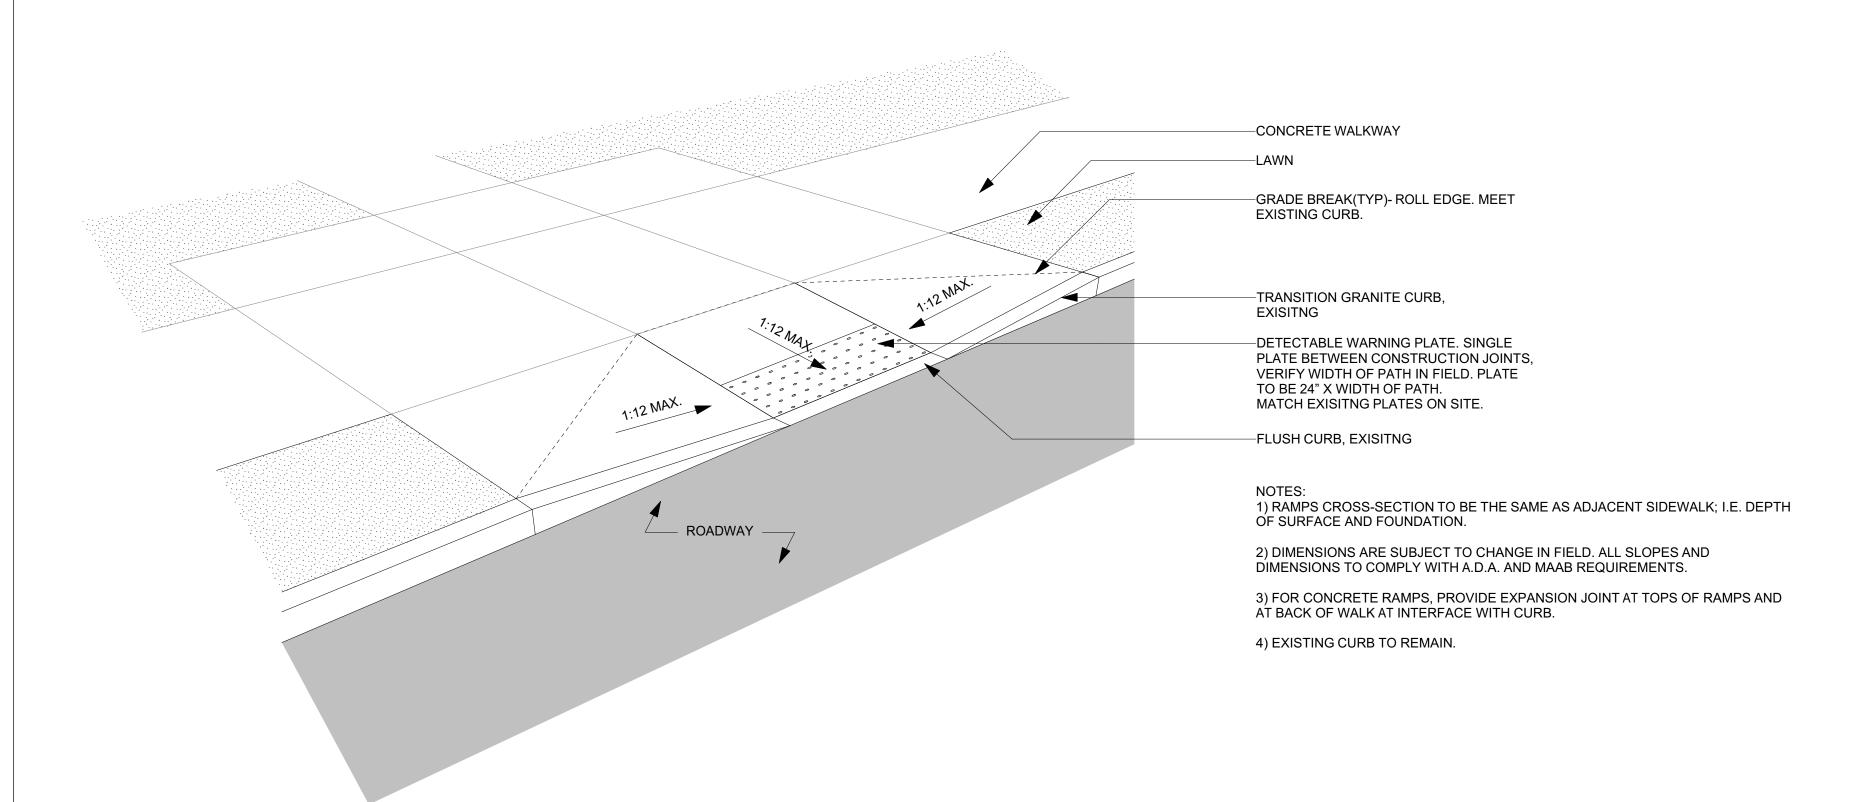





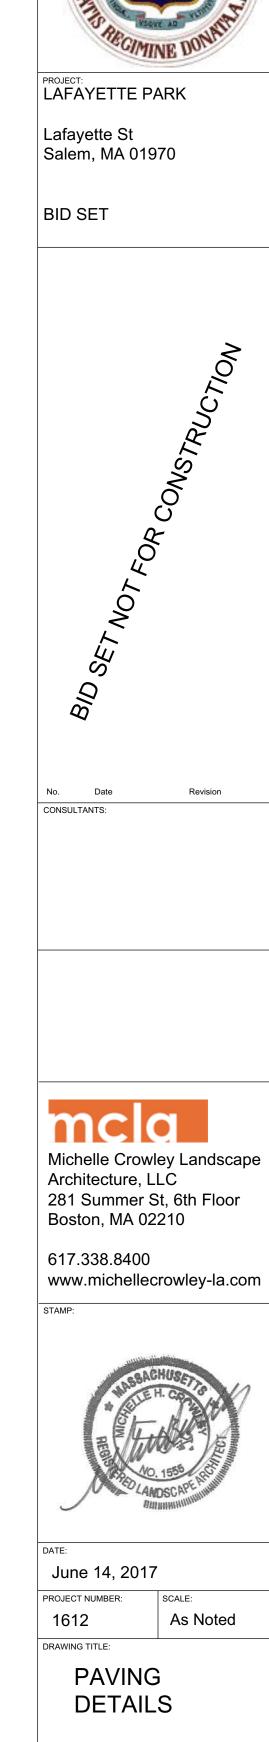

L5.00

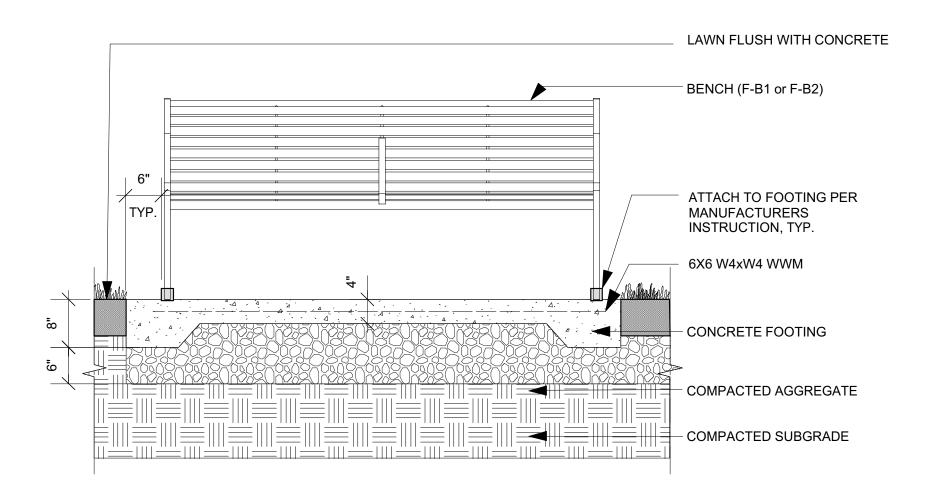


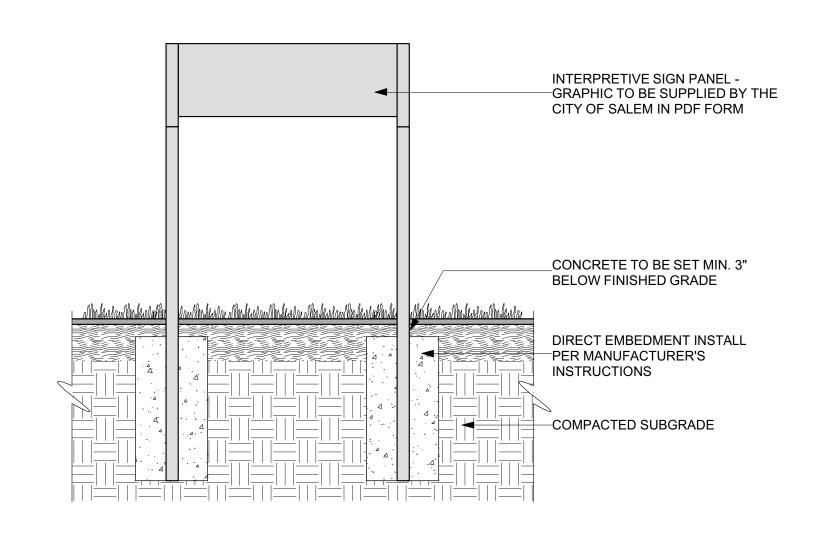

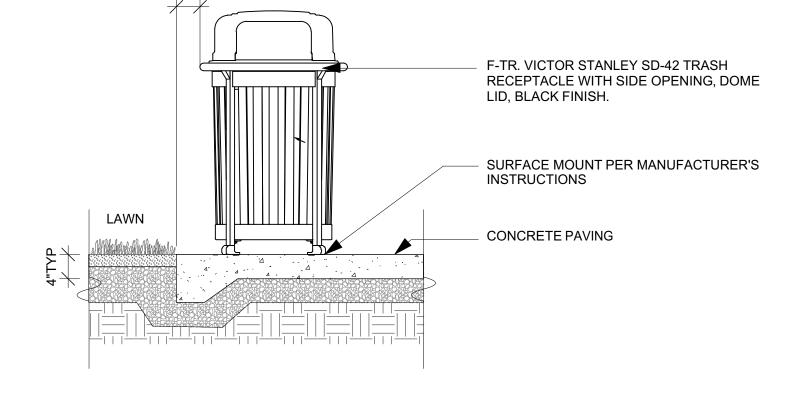



2 (F-S1) INTERPRETIVE SIGN PANEL Scale: 3/4" = 1'-0" 3 (F-TR) TRASH RECEPTACLE
Scale: 3/4" = 1'-0"

VARIES, SEE LAYOUT PLAN

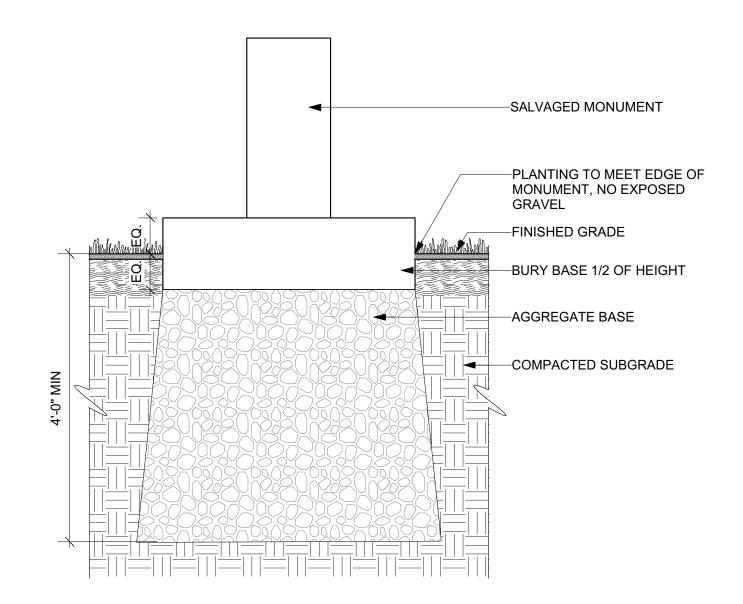

(F-B1) (F-B2) BACKLESS BENCH, SALVAGED BENCH Scale: 3/4" = 1'-0"

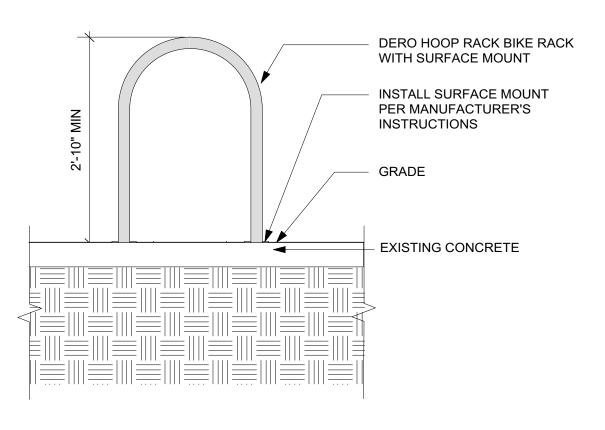

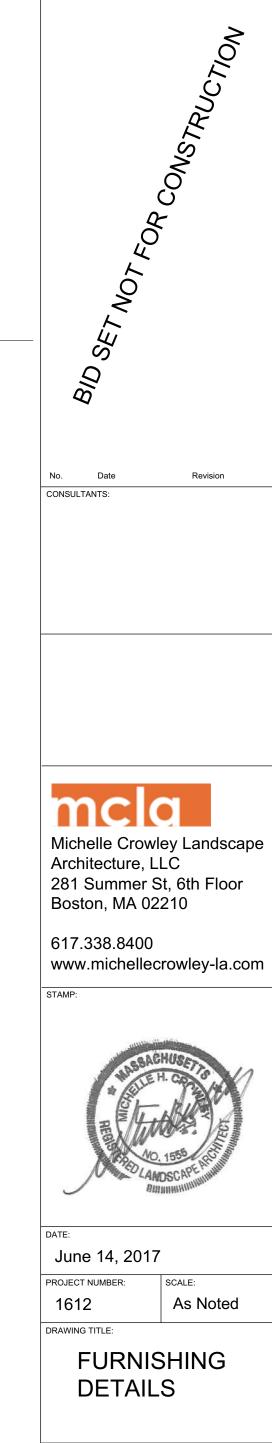


L5.10

PROJECT: LAFAYETTE PARK

Lafayette St Salem, MA 01970


BID SET



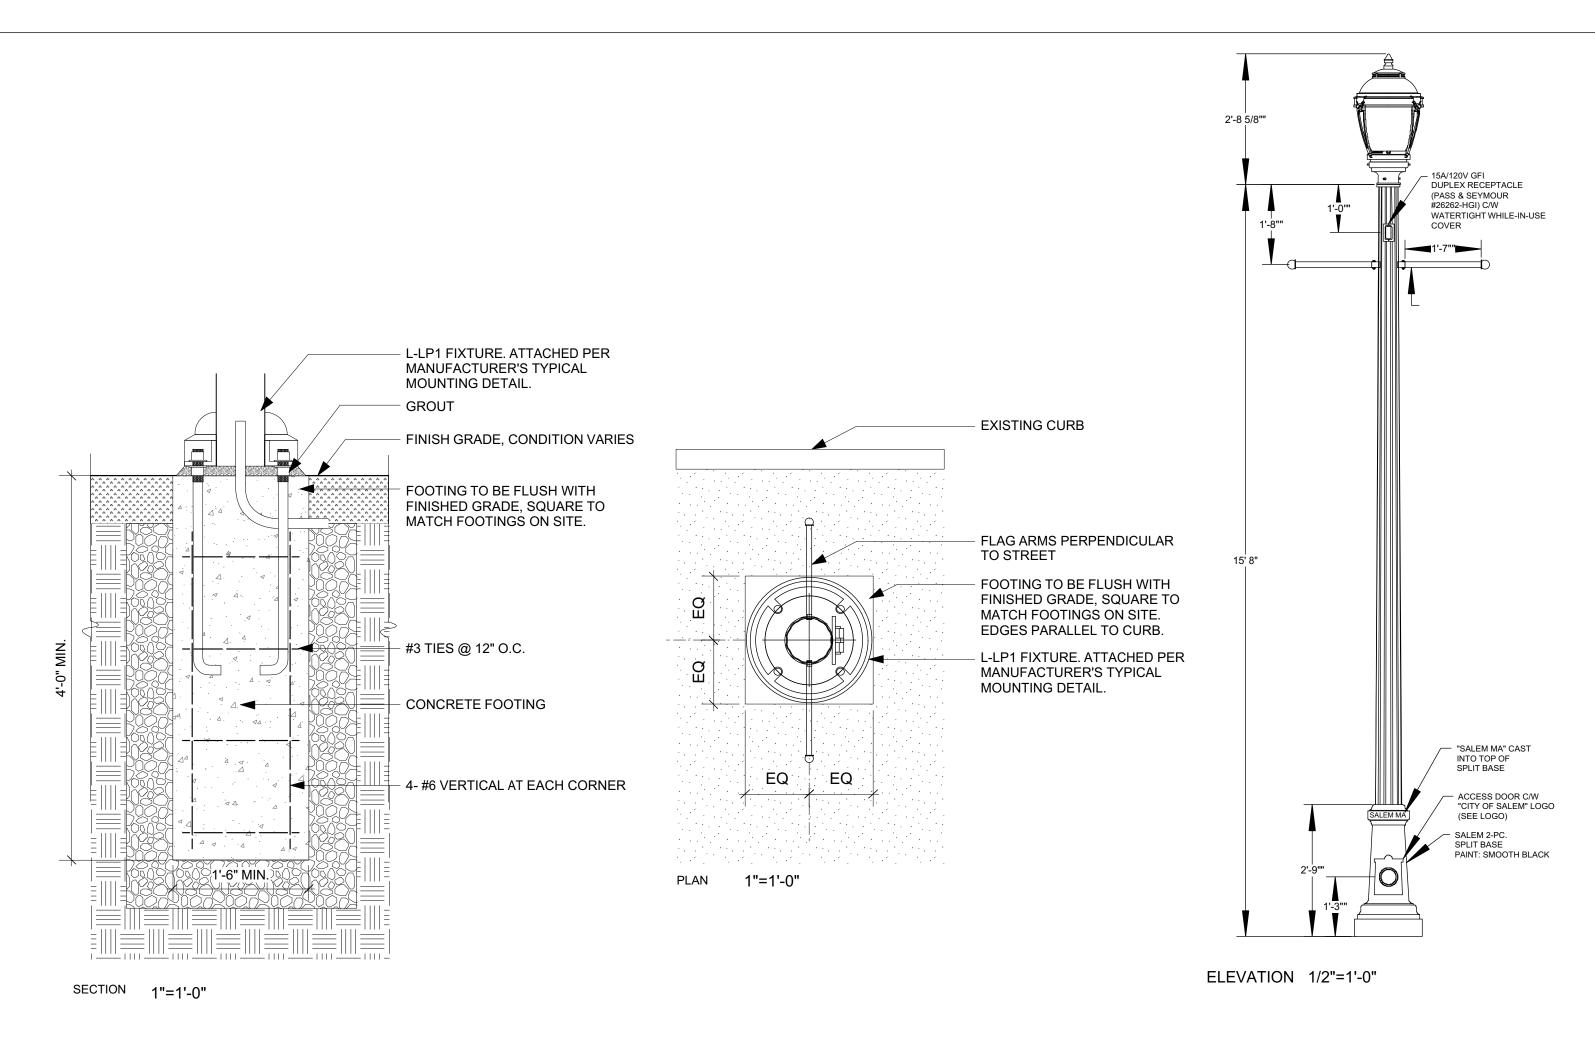



2 (F-LP) LIGHT POST AS NOTED

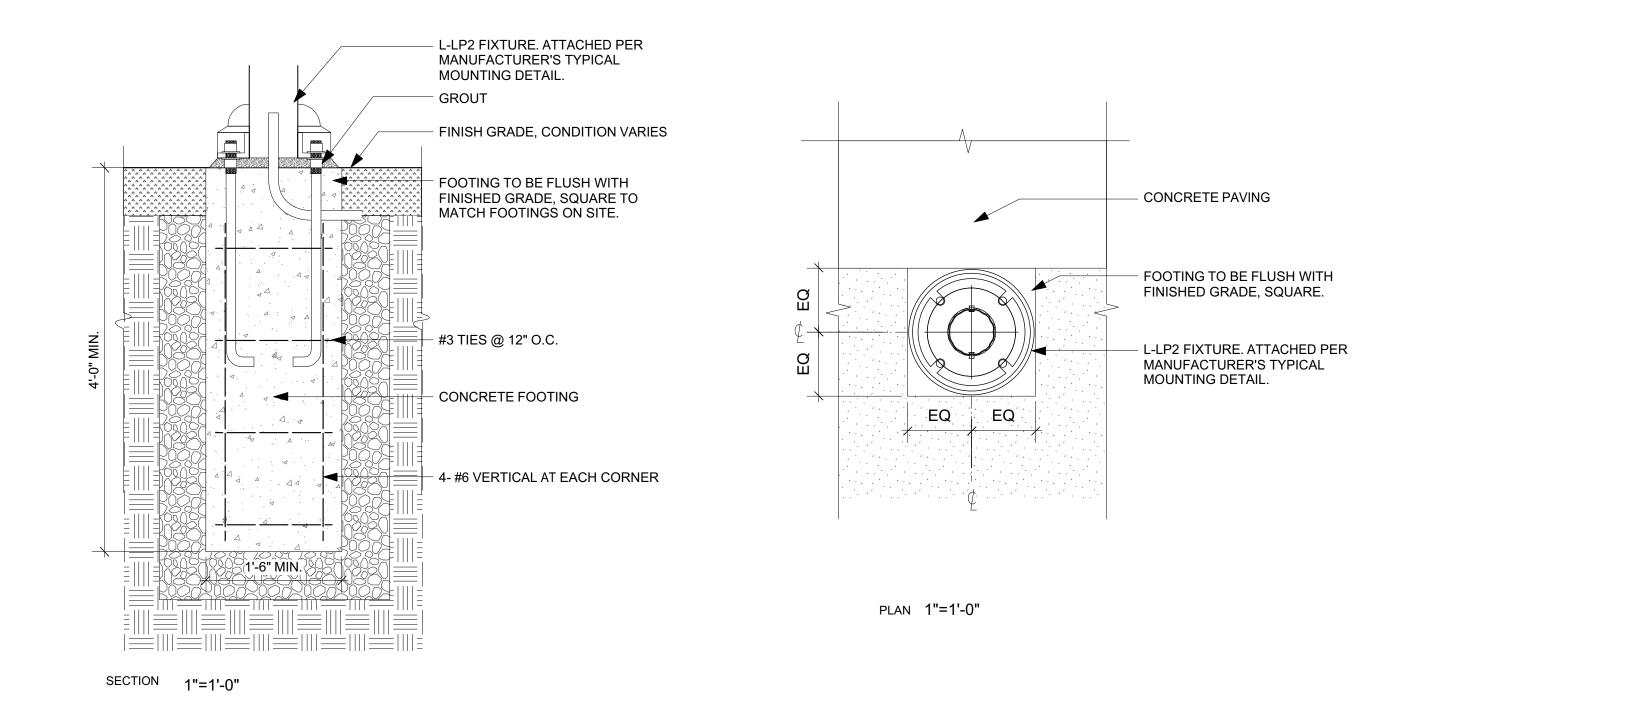




LAFAYETTE PARK

Lafayette St Salem, MA 01970

BID SET

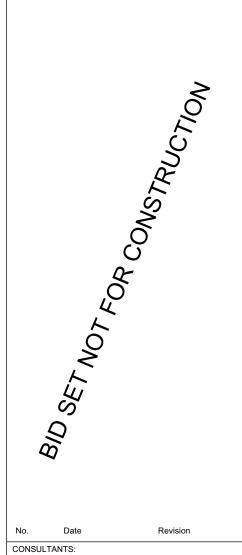

Michelle Crowley Landscape Architecture, LLC 281 Summer St, 6th Floor

617.338.8400 www.michellecrowley-la.com

Boston, MA 02210



June 14, 2017


1612


DRAWING TITLE:


As Noted

LIGHTING **DETAILS**

L5.11

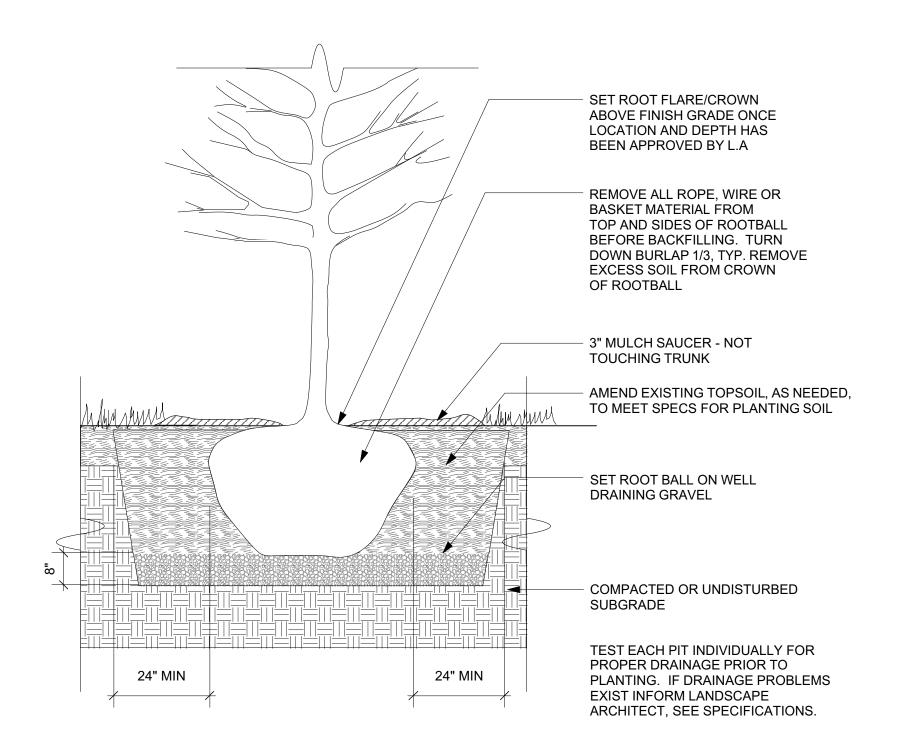

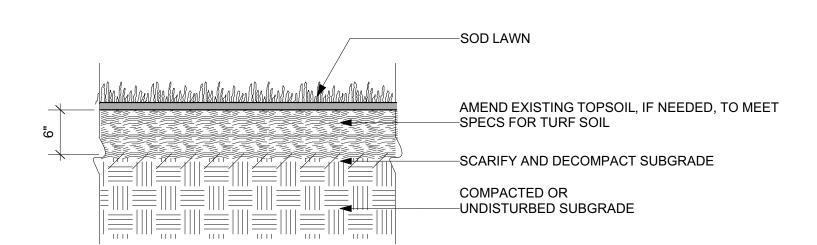

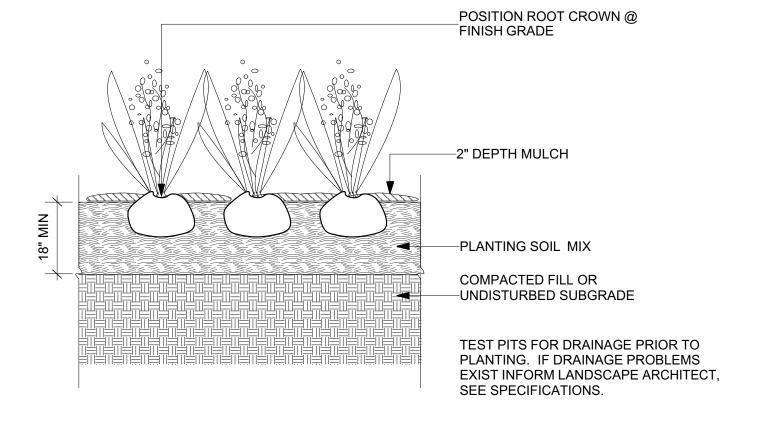


1 (PL-TR) TREE Scale: 1/2" = 1'-0" 2 (PL-SD) SOD Scale: 1" = 1'-0" 3 (PL-PR) PERENNIAL Scale: 1/2" = 1'-0"



PROJECT:
LAFAYETTE PARK

Lafayette St Salem, MA 01970

BID SET

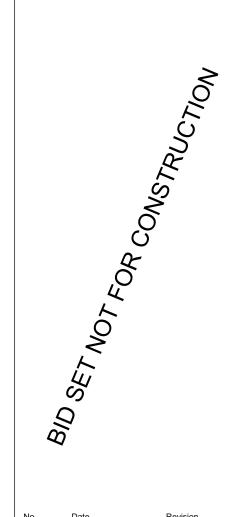

CONSULTANTS:

Michelle Crowley Landscape Architecture, LLC 281 Summer St, 6th Floor Boston, MA 02210

617.338.8400 www.michellecrowley-la.com



June 14, 2017

PROJECT NUMBER: SCALE:

1612 As Noted

PLANTING DETAILS

L5.20

GENERAL SPECIFICATIONS

- 1. CONDITIONS OF THE CONTRACT AND DIVISION 1, GENERAL REQUIREMENTS APPLY TO WORK SHOWN ON THESE DRAWINGS. EXAMINE DRAWINGS AND OTHER SPECIFICATIONS FOR REQUIREMENTS THAT AFFECT WORK SHOWN ON THESE DRAWINGS.
- 2. PROVIDE ITEMS REFERRED TO IN SINGULAR NUMBER IN CONTRACT DOCUMENTS IN QUANTITIES NECESSARY TO COMPLETE
- 3. VISIT SITE AND EXAMINE CONDITIONS UNDER WHICH WORK MUST BE PERFORMED. REPORT ADVERSE CONDITIONS IN WRITING TO ENGINEER. COMMENCEMENT OF WORK SHALL BE CONSTRUED AS COMPLETE ACCEPTANCE OF EXISTING CONDITIONS INCLUDING PREPARATORY WORK DONE BY OTHERS.
- 4. PERFORM WORK AND PROVIDE MATERIALS AND EQUIPMENT AS SHOWN ON DRAWINGS. COORDINATE ELECTRICAL WORK WITH WORK SHOWN ON THESE DRAWINGS.
- 5. GIVE NOTICES, FILE PLANS, OBTAIN PERMITS AND LICENSES, PAY FEES AND BACK CHARGES, AND OBTAIN NECESSARY APPROVALS FROM AUTHORITIES THAT HAVE JURISDICTION.
- 6. PERFORM WORK AS REQUIRED BY CODES, REGULATIONS AND LAWS OF LOCAL, STATE AND FEDERAL GOVERNMENTS AND OTHER AUTHORITIES WITH LAWFUL JURISDICTION.
- 7. MATERIAL AND EQUIPMENT SHALL BE UL, NEMA, ANSI, IEEE, ADA & CBM APPROVED FOR INTENDED SERVICE. MATERIAL AND INSTALLATION SHALL MEET REQUIREMENTS OF NATIONAL AND STATE ELECTRICAL CODE.
- 8. DRAWINGS ARE DIAGRAMMATIC AND INDICATE GENERAL ARRANGEMENT OF SYSTEMS.
- 9. UTILIZE EXITING MOLDED CASE CIRCUIT BREAKERS. MINIMUM INTERRUPTING CAPACITY SHALL BE 10,000 AMPS SYMMETRICAL AT 208 VOLTS.
- 10. ADDRESS QUESTIONS REGARDING DRAWINGS TO ARCHITECT IN WRITING BEFORE AWARD OF CONTRACT. OTHERWISE, ARCHITECT INTERPRETATION OF MEANING AND INTENT OF DRAWINGS SHALL BE FINAL.
- 11. SUBMIT SHOP DRAWINGS AND PRODUCT DATA WITHIN TEN (10) DAYS AFTER AWARD OF CONTRACT. CHECK, STAMP AND MARK WITH PROJECT NAMES SUBMITTALS BEFORE TRANSMITTING TO ENGINEER. INDICATE DEVIATIONS FROM CONTRACT DOCUMENTS. SHOP DRAWINGS SHALL BE PROVIDED FOR ALL EQUIPMENT SHOWN ON THE DRAWINGS. PROVIDE SHOP DRAWINGS ON LIGHTING, CIRCUIT BREAKERS, CONDUIT, WIRING DEVICES, TIME CLOCK, PHOTOCELL, CABLE AND
- 12. SCHEDULE AT LEAST FIVE (5) WORKING DAYS, EXCLUSIVE ON TRANSMITTAL TIME FOR SUBMITTAL REVIEW.
- 13. ALL WIRING SHALL BE RUN CONCEALED UNLESS SPECIFIED OTHERWISE.
- 14. CONTRACTOR SHALL REVIEW ALL TRADES' CONTRACT DOCUMENTS TO DETERMINE SPECIFIC MOUNTING LOCATIONS FOR ELECTRICAL EQUIPMENT. COORDINATE EXACT MOUNTING LOCATIONS WITH THE ENGINEER.
- 15. BRANCH CIRCUIT WIRING MAY NOT BE SHOWN GRAPHICALLY ON DRAWINGS AND MAY BE INDICATED BY CIRCUIT NUMBERS BESIDE FIXTURES, DEVICES AND EQUIPMENT. PROVIDE COMPLETE WIRING SYSTEM WHETHER OR NOT INDICATED
- 16. ALL NEW WIRING SHALL BE TYPE THHN/THWN RATED 75-90°C, 600V. WET-DRY LOCATIONS. MINIMUM BRANCH CIRCUIT WIRING SHALL BE NO. 10 AWG SOLID COPPER.
- 17. EXTERIOR WIRING SHALL BE IN GALVANIZED RIGID METALLIC CONDUIT AND PVC SCHEDULE 40.
- 18. ALL GROUNDING SHALL BE PERFORMED IN ACCORDANCE WITH THE NATIONAL ELECTRICAL CODE AS AMENDED BY THE STATE OF MASSACHUSETTS.
- 19. PROVIDE TYPED IDENTIFICATION DIRECTORY IN LOADCENTER INDICATING CIRCUIT FUNCTION OR EQUIPMENT SERVED.
- 20. ALL CONDUITS ARE SHOWN DIAGRAMMATICALLY. EXACT LOCATION AND METHOD OF SUPPORT SHALL BE DETERMINED IN THE FIELD, EXCEPT WHERE SPECIFIC DIMENSIONS AND DETAILS ARE SHOWN. ALL CONDUIT RUNS SHALL BE RIGIDLY SUPPORTED.
- 21. NO CONDUIT SMALLER THAN 3/4 INCH ELECTRICAL TRADE SIZE SHALL BE USED, UNLESS SPECIFICALLY CALLED FOR ON THE DRAWINGS.
- 22. PERFORM WORK AND PROVIDE MATERIALS AND EQUIPMENT TO MAKE INSTALLATION COMPLETE IN EVERY DETAIL UNDER THIS CONTRACT WHETHER OR NOT SPECIFICALLY SHOWN ON DRAWINGS.
- 23. CONDUCTORS AND CABLE SHALL BE MINIMUM #10 AWG, 600 VOLT, COPPER WITH TYPE THHN/THWN INSULATION. PROVIDE SEPARATE GREEN GROUND IN ALL BRANCH CIRCUITS. #12 AWG AND SMALLER SHALL BE SOLID. COLOR CODE CONDUCTORS BLACK, RED, BLUE, WITH WHITE NEUTRAL AND GREEN GROUND EXCEPT AS NOTED FOR 120 VOLT.

ABBREVIATIONS

CONDUCTORS.

A/AMP	AMPERE	IMC	INTERMEDIATE METALLIC CONDUIT
AC	ALTERNATING CURRENT	JB	JUNCTION BOX
AF	AMPERE FRAME	KVA	KILOVOLT-AMPERE
AFF	ABOVE FINISHED FLOOR	KW	KILOWATT
AFG	ABOVE FINISHED GRADE	LTG	LIGHTING
AIC	APRERE INTERRUPTING CAPACITY	PWR	POWER
AL	ALUMINUM	MCB	MAIN CIRCUIT BREAKER
AT	AMPERE TRIP	MEC	MASSACHUSETTS ELECTRICAL CODI
ATS	AUTOMATIC TRANSFER SWITCH	MLO	MAIN LUGS ONLY
AWG	AMERICAN WIRE GAUGE	MTG	MOUNTING
С	CONDUIT	MTD	MOUNTED
CKT	CIRCUIT	MCC	MOTOR CONTROL CENTER
CB	CIRCUIT BREAKER	NEC	NATIONAL ELECTRICAL CODE
CU	COPPER	NS	NON-SYSTEM
CL	CENTERLINE	NTS	NOT TO SCALE
DC	DIRECT CURRENT	No., #	NUMBER
DE	DUAL ELEMENT	PC "	PLUMBING CONTRACTOR
DWG	DRAWING	RPM	REVOLUTIONS PER MINUTE
EC	ELECTRICAL CONTRACTOR	RMS	ROOT MEAN SQUARE VALUE
EMH	ELECTRICAL MANHOLE	RGS	RIGID STEEL CONDUIT
EWC	ELECTRIC WATER COOLER	SF	SQUARE FOOT
EMT	ELECTRIC METALLIC CONDUIT	SN	SOLID NEUTRAL
FLMT	FLEXIBLE LIQUID TIGHT METALLIC TUBING	SWBD	SWITCHBOARD
GC	GENERAL CONTRACTOR	TYP	TYPICAL
GND	GROUND	V	VOLTS
GFI	GROUND FAULT INTERRUPTING	VA	VOLT-AMPERE
HVAC	HEATING, VENTILATION AND AIR CONDITIONING	VFD	VARIABLE FREQUENCY DRIVE
HP	HORSEPOWER	WP	WEATHERPROOF

BRANCH CIRCUIT AND FEEDER SYMBOLS

BRANCH CIRCUIT OR FEEDER CONCEALED UNLESS OTHERWISE NOTED

BRANCH CIRCUIT DIAGONAL LINES INDICATE NUMBER OR CONDUCTORS, NO DIAGONAL LINES INDICATES TWO (2) CONDUCTORS (1 PHASE AND 1 NEUTRAL). GROUND WIRE(S) NOT INDICATED. MINIMUM SIZE CONDUCTOR #10 AWG AND 3/4" CONDUIT, UNLESS OTHERWISE NOTED

4#1,1#6G-1½°C INDICATES (3) #1 AWG(PHASE), (1)#1 AWG(NEUTRAL), (1) #6 GROUND IN A 1-1/2° CONDUIT

HOMERUN TO PANELBOARD 'P1' CIRCUIT NUMBER 1. DIAGONAL LINES INDICATE (1) PHASE AND (1) NEUTRAL CONDUCTOR. (1) GROUNDING CONDUCTOR UNDERSTOOD. **]** 20A/1P

▶ PP1-1,3 HOMERUN TO PANELBOARD 'P1' CIRCUIT NUMBER 1 & 3. DIAGONAL LINES INDICATE (2) PHASE AND (2) NEUTRAL (2)20A/1P CONDUCTOR. (2) GROUNDING CONDUCTOR UNDERSTOOD.

LIGHTING FIXTURE SYMBOLS

POLE TOP MOUNTED LIGHT FIXTURE, "B" DENOTES LIGHTING FIXTURE TYPE, "4" DENOTES CIRCUIT NUMBER. SEE DETAIL 1, THIS DRAWING.

SIDE POLE MOUNTED SPOT LIGHT LIGHT FIXTURE, "A" DENOTES LIGHTING FIXTURE TYPE, "4" DENOTES CIRCUIT NUMBER.

RECEPTACLES AND OUTLETS



DUPLEX GROUND FAULT INTERRUPTING RECEPTACLE, RATED 20A, 125V TYPE. "5" DENOTES CIRCUIT NUMBER, MOUNTING HEIGHT 18" TO CENTERLINE AFF. WP DENOTES A WATERTIGHT WHILE IN USE ENCLOSURE. PASS&SEYMOUR#26262-HGI

LOADCENTER AND CONTROLS

POWER LOADCENTER, SURFACE MOUNTED, 120/208 VOLT

EQUIPMENT CONTROL PANEL

SITE SYMBOLS

UNDERGROUND CONDUIT OR DUCTBANK

MISCELLANEOUS

UTILITY METER


TIME CLOCK.



LAFAYETTE PARK


Lafayette St Salem, MA 01970

BID SET

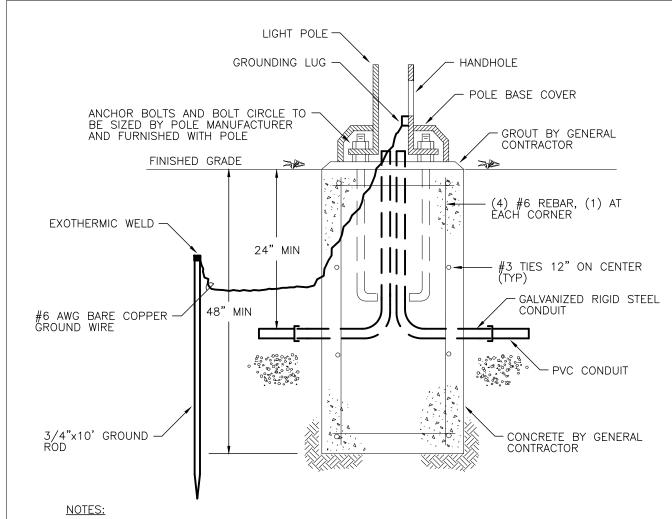

- 1. FURNISH POLE BASE TEMPLATE TO GENERAL CONTRACTOR PRIOR TO CONCRETE POUR.
- 2. REFER TO STRUCTURAL AND ARCHITECTURAL DRAWINGS FOR BASE SIZE AND REBAR REQUIREMENTS.
- 3. PROVIDE GROUNDING BUSHINGS PER NATIONAL ELECTRICAL CODE.



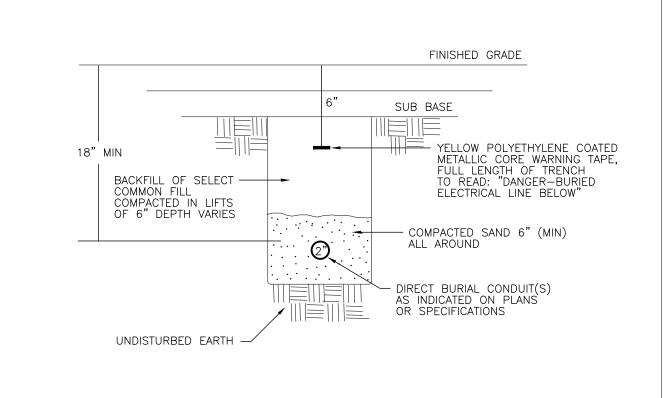

281 Summer St, 6th Floor Boston, MA 02210 617.338.8400

Architecture, LLC

Michelle Crowley Landscape

Revision


BLW Engineers, Inc.

311 Great Road, Post Office Box 1551

Littleton, Massachusetts 01460 T: 978.486.4301 F: 978.428.0067


HVAC * ELECTRICAL * PLUMBING * FIRE PROTECTION

www.michellecrowley-la.com

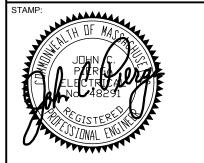

June 14, 2017 NTS 1612

ELECTRICAL SPECIFICATIONS SYMBOLS AND DETAILS

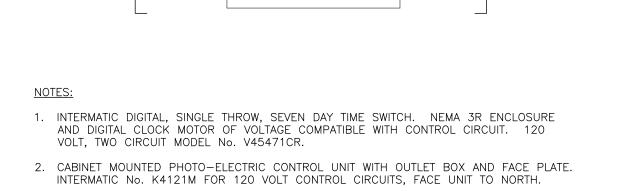


TO LINE, REFER TO DRAWING FOR

COMPLETE INFORMATION

(2) TIME SWITCH PHOTOCELL CONTROLLED CONTACTOR DETAIL N.T.S. (3) DIRECT BURIAL CONDUIT DETAIL

TO LOAD, REFER TO DRAWING FOR COMPLETE INFORMATION

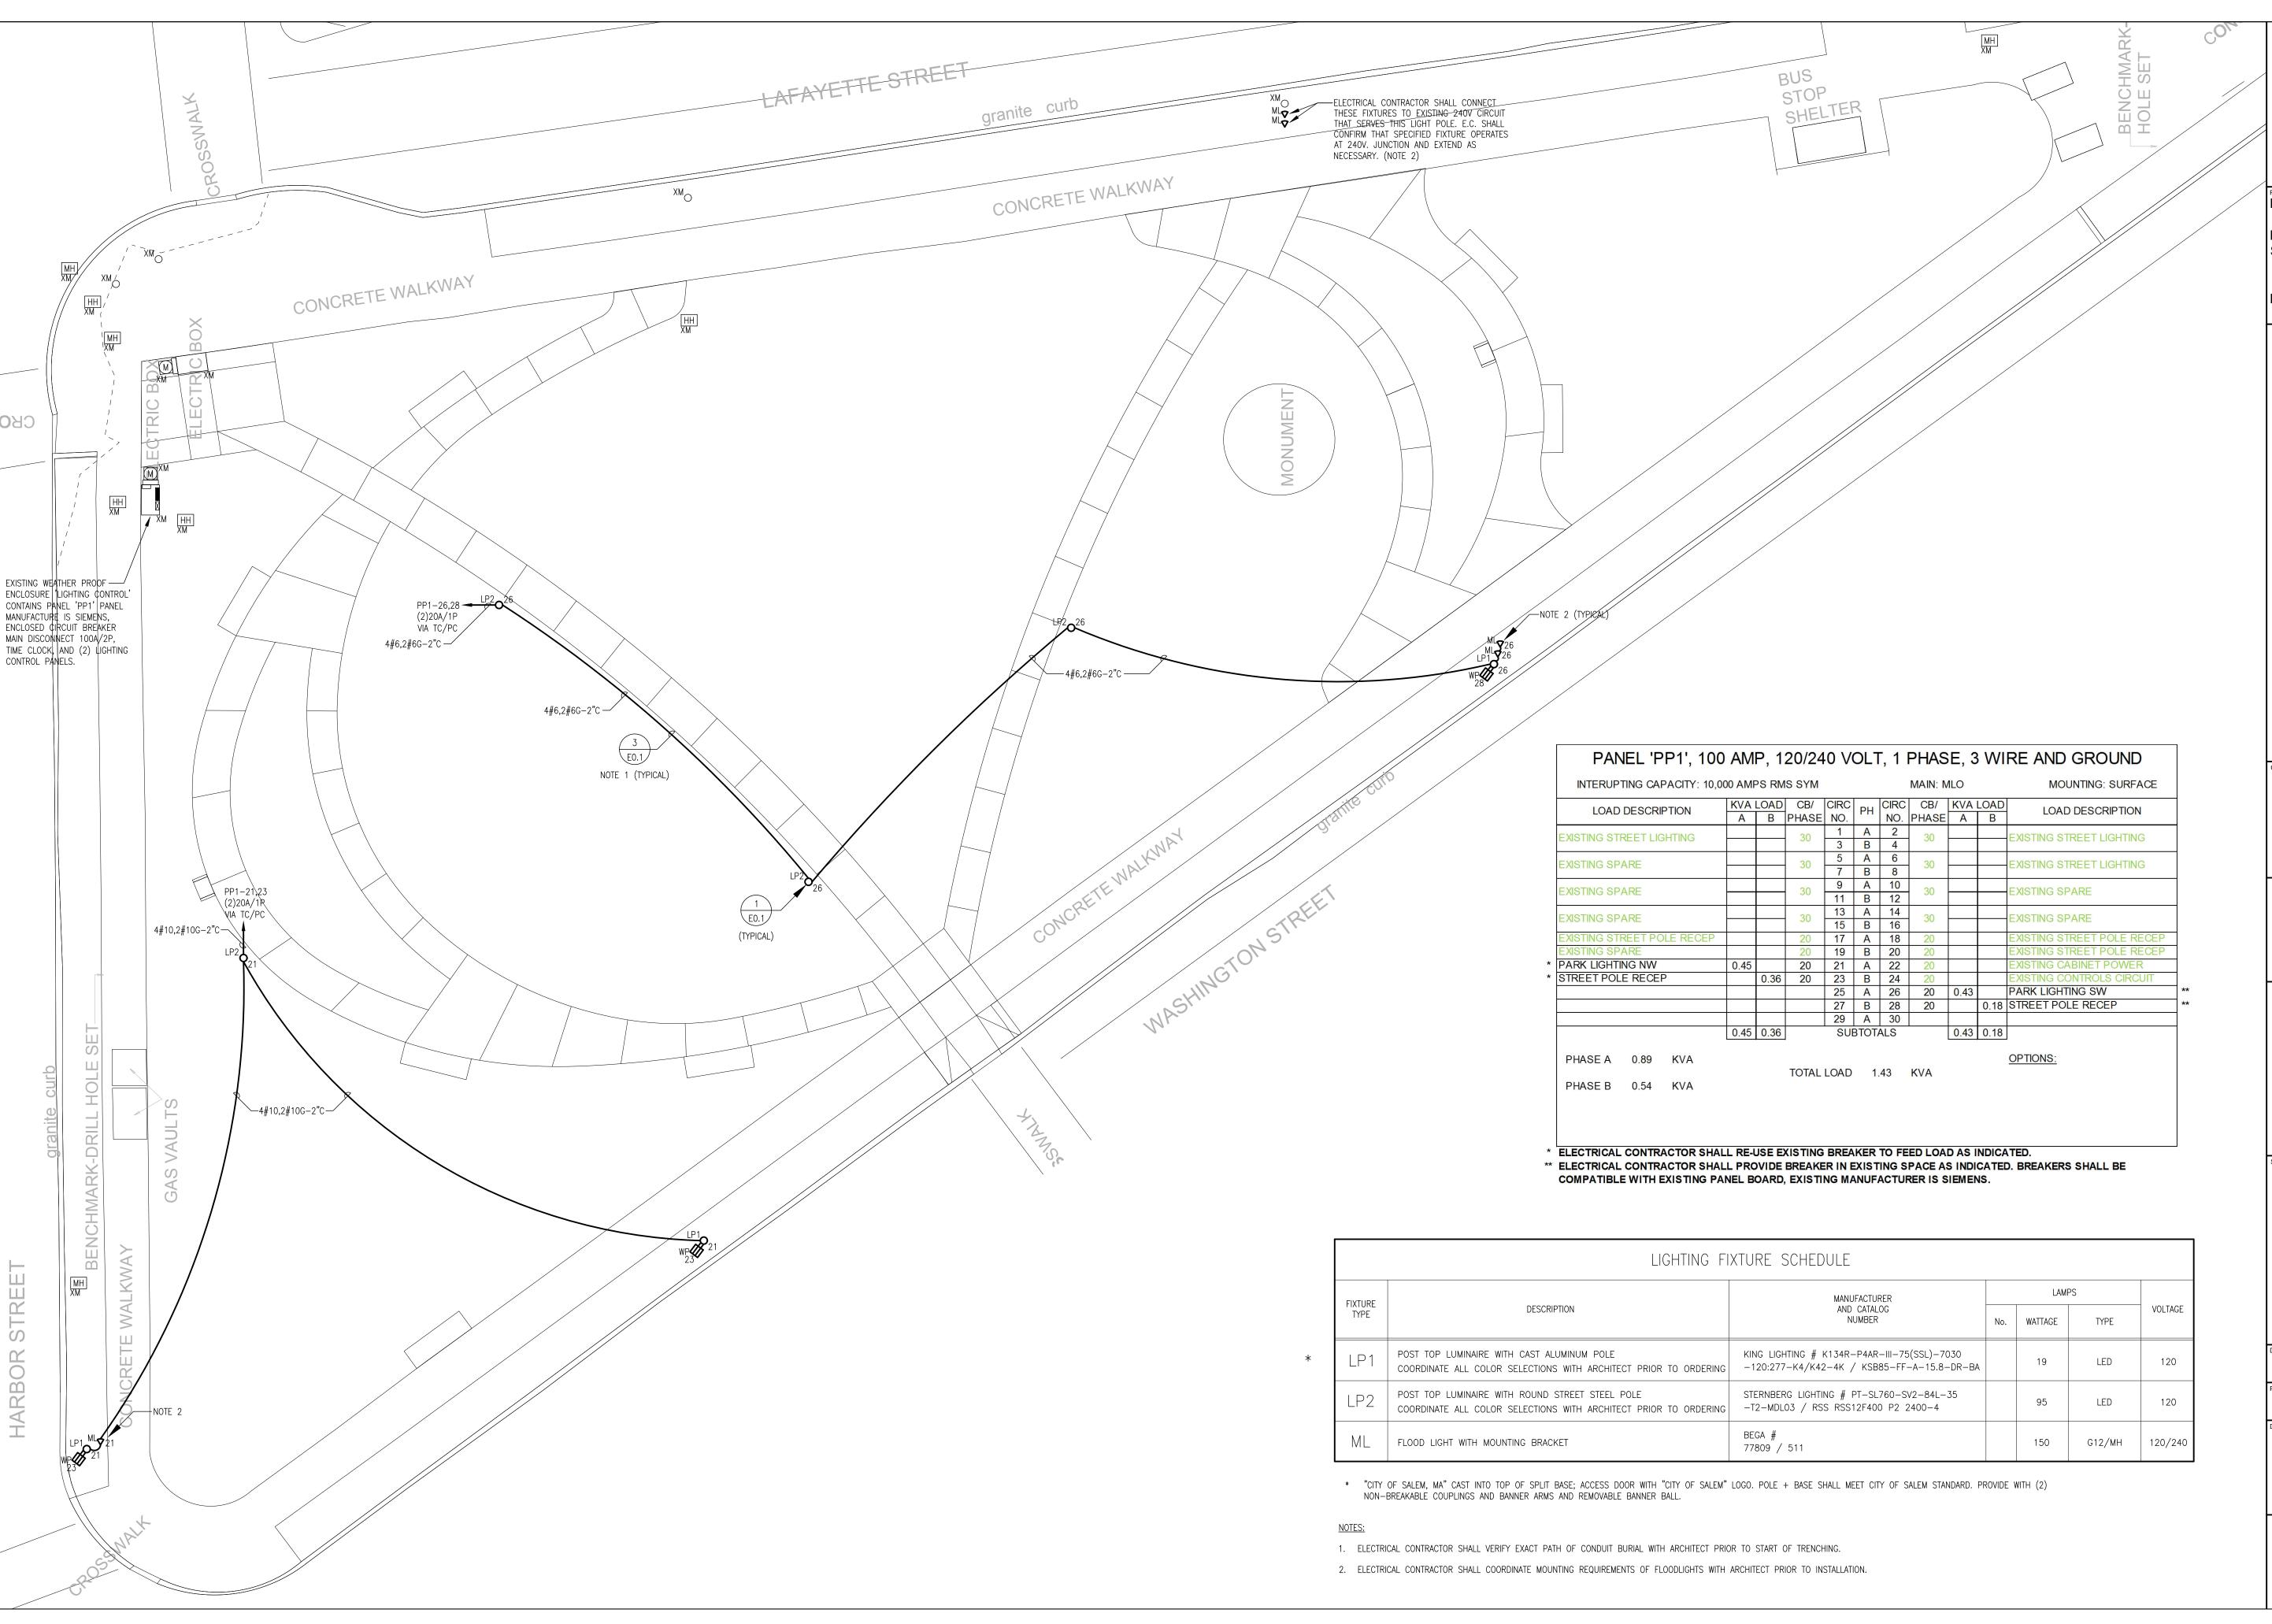

CWITTE DOWNER DO

PROJECT:

LAFAYETTE PARK

Lafayette St Salem, MA 01970

BID SET

Date Revision

BLW Engineers, Inc.


311 Great Road, Post Office Box 1551
Littleton, Massachusetts 01460
T: 978.486.4301 F: 978.428.0067
www.blwengineers.com

HVAC * ELECTRICAL * PLUMBING * FIRE PROTECTION

ncla

Michelle Crowley Landscape Architecture, LLC 281 Summer St, 6th Floor Boston, MA 02210

617.338.8400 www.michellecrowley-la.com

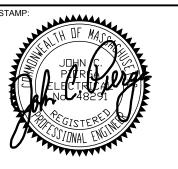

June 14, 2017

PROJECT NUMBER: SCALE: 1"-10'-0"

ELECTRICAL SITE PLAN

E1.0